PREMIER STRUCTURAL INSULATED PANELS

MANUFACTURING/SALES
PREMIER BUILDING SYSTEMS, LLC.

18504 Canyon Rd E.

PUYALLUP, WA 98375

OFFICE-800.275.7086

NOTES:

7-ELEVEN #1042626

GENERAL NOTES

- PREMIER IS A MATERIAL SUPPLIER AND NOT A BUILDER. PROPER INSTALLATION OF OUR PRODUCT SHOULD BE DONE BY A QUALIFIED CONTRACTOR. IT IS THE CONTRACTORS RESPONSIBILITY TO COMPLY WITH ALL APPLICABLE AND LOCAL CODES AND REGULATIONS.
- 2. SHOP DRAWINGS ARE PREMIER'S INTERPRETATION OF THE PLANS PROVIDED. THE CONTRACTOR SHALL REVIEW ALL SHOP DRAWINGS AND VERIFY ALL DIMENSIONS WITH ARCHITECT. PANELS ARE FABRICATED PER THESE SHOP DRAWINGS. ANY DISCREPANCIES OR MISSING ITEMS IN THESE SHOPS SHOULD BE NOTED.
- PREMIER SHOP DRAWINGS ARE TO BE USED IN CONJUNCTION WITH ARCHITECTURAL AND STRUCTURAL DRAWINGS. IF ANYTHING IS NOT CLEAR OR THERE ARE QUESTIONS THEY SHOULD BE IMMEDIATELY DIRECTED TO THE ENGINEER OF RECORD.
- 4. CONTRACTOR SHOULD LOOK THROUGH THE PLANS CAREFULLY TO INSURE THAT ALL ASPECTS OF SIP PACKAGE CAN BE CONSTRUCTED THROUGH THEIR PREFERRED MEANS AND METHODS PRIOR TO SIGNING OFF ON THE SHOP DRAWINGS.
- 5. EXECUTION OF WORK FOR SIP PACKAGE MAY REQUIRE COORDINATION WITH OTHER TRADES (I.E. ELECTRICIAN, HVAC, WINDOW/DOOR MANUFACTURER, ETC...). THIS COORDINATION IS THE RESPONSIBILITY OF THE CONTRACTOR.
- WHEN BUILT PROPERLY A SIP BUILDING PROVIDES A TIGHT ENVELOPE. IT IS THE RESPONSIBILITY OF THE CONTRACTOR TO ENSURE THAT THE SIP STRUCTURE IS PROPERLY VENTILATED TO ENSURE PROPER AIR QUALITY AND HUMIDITY LEVELS.
- 7. IT IS THE CONTRACTOR'S SOLE RESPONSIBILITY TO ENSURE THAT ALL SPLINES ARE PROPERLY SEATED INTO THE PANEL RECESSES AND COMPLETELY SEALED WITH MASTIC OR EXPANDING SPRAY FOAM, INCLUDING BUT NOT LIMITED TO SPLINE JOINTS, PENETRATIONS, LIFTING HOLES, ETC. VOIDS BETWEEN SPLINE JOINTS ARE NOT ACCEPTABLE IN A PROPER SIP INSTALLATION.
- 8. THE CONTRACTOR IS RESPONSIBLE TO DETERMINE THE PROPER WEATHER BARRIER (I.E. HOUSE WRAPS, FLASHING, ROOF UNDERLAYMENT, ETC..) TO DRY IN THE BUILDING ENVELOPE.
- 9. SOME DIMENSIONS CAN NOT BE VERIFIED UNTIL CONSTRUCTED. THEREFORE PREMIER TAKES NO RESPONSIBILITY FOR FIELD FABRICATION. SOME FIELD FABRICATED AREAS MAY HAVE BEEN HIGHLIGHTED ON THE DRAWINGS BUT MAY NOT BE LIMITED TO ONLY THOSE AREAS.
- 10. YOU MAY EXPERIENCE DIMENSIONAL VARIANCES FROM THE CONSTRUCTION DRAWINGS AS PANELS ARE ASSEMBLED DUE TO GAPS AT PANEL JOINTS AND ADDITIONAL MISCELLANEOUS CONSTRUCTION VARIABLES SUCH AS FABRICATION TOLERANCES, LUMBER POST THICKNESS VARIANCES, ETC. FIELD CUTTING THE SIPS MAY BE REQUIRED TO ENSURE THAT THE TOTAL WALL OR ROOF ASSEMBLY IS PER THE CONSTRUCTION DRAWINGS. PREMIER WILL ADD GAPS AS INDICATED ON PANEL LAYOUTS BETWEEN PANEL JOINTS IN THE SHOP DRAWINGS (TYPICALLY 1/8" GAP).
- 11. IT IS THE BUILDERS RESPONSIBILITY TO DETERMINE ALL MATERIALS NECESSARY FOR PANEL INSTALLATION. THIS INCLUDES VERIFYING THAT THE MATERIALS PREMIER WILL BE PROVIDING ARE ADEQUATE FOR THE PROJECT AND SOURCE ANY ADDITIONAL MATERIALS REQUIRED FOR PANEL INSTALLATION THAT ARE NOT PROVIDED BY PREMIER.


REVIEWING PANEL LAYOUT DRAWINGS

TWO ROUNDS OF REVISIONS/EDITS ARE INCLUDED IN THE INITIAL PRE-PRODUCTION SERVICES PORTION OF THE PBS ESTIMATE. ADDITIONAL REVISIONS MAY INCUR ADDITIONAL FEES.

WHEN REVIEWING SHOP DRAWINGS, BEGIN BY CHECKING ALL OF THE OVERALL DIMENSIONS OF THE PROJECT. IF THE PROJECT HAS FLOOR PANELS, PLEASE CHECK POINT LOAD LOCATIONS FOR SOLID BLOCKING AND MAKE SURE ANY OPENINGS OR STEP DOWNS ARE CORRECT. AFTER THE FLOORS HAVE BEEN COMPLETELY CHECKED, MOVE TO THE WALLS. THE WALLS WILL BE SHOWN ON A KEYED FLOOR PLAN WITH WALL NUMBERS CALLED OUT AND AN ARROW POINTING THE VIEW DIRECTION OF EACH OF THE PANEL WALL LAYOUTS. THESE NUMBERS AND THEIR ORIENTATION WILL ALSO BE LOCATED BELOW EVERY PANELIZED WALL. OBSERVE THE LOCATION OF THE PANEL CORNER LAPS. SOME OF THE WALLS WILL BE SHORTER DUE TO CORNER LAPS AND TO THE PANEL THICKNESS. AFTER YOU HAVE MADE SURE ALL DIMENSIONS MATCH YOUR ARCHITECTURAL PLANS, MOVE TO THE WINDOWS AND DOORS. MAKE SURE THAT THE ROUGH OPENINGS FOR THE WINDOWS AND DOORS ARE THE CORRECT SIZE AND ARE LOCATED PROPERLY. IF THE ROOF FOR THE PROJECT IS ALSO PANELS, CHECK THE ROOF PITCH, RIDGE LOCATION, AND THE OVERHANGS AT THE EAVES AND GABLES. EVEN IF THE ROOF IS A SYSTEM OTHER THAN PANELS, GABLE WALL HEIGHTS MAY BE DEPENDENT ON HEEL HEIGHTS OR BE NOTCHED FOR LOOK OUT SUPPORTS. IF THERE ARE SKYLIGHTS CHECK THE ROUGH OPENINGS FOR CORRECT SIZE AND LOCATION. PANEL DRAWINGS ARE TO BE REVIEWED BY OWNER/AGENT AND APPROVED BY OWNER, CONFIRMING ALL DIMENSIONS. OWNER IS RESPONSIBLE FOR VERIFYING ALL PANEL DRAWING DIMENSIONS TO ENSURE PROPER ASSEMBLY. CHECK CORRECT DIMENSIONS AND CLOUD CHANGED DIMENSIONS WITH AN APPROPRIATE ARROW REFERENCING THE DIRECTION OF CHANGE. UNCHECKED DIMENSIONS MAY RESULT IN FIELD FABRICATION.

WHEN YOU HAVE FINISHED VERIFYING THE SHOP DRAWINGS AND HAVE MADE ANY CHANGES/CORRECTIONS, COPY THOSE CHANGES TO THE SHOP DRAWINGS AND SEND BACK TO PREMIER FOR REVISIONS.


ANY AND ALL DISCREPANCIES RELATED TO PANELS ON SITE ARE THE RESPONSIBILITY OF OWNER UNLESS THERE IS A DIFFERENCE BETWEEN FABRICATED PANELS AND SIGNED SHOP DRAWINGS. PREMIER HOLDS FIRST RIGHT OF DECISION TO REPLACE, REPAIR OR PAY FOR REPAIR OF ALL PRODUCTS IN DISCREPANCY WITH FINAL SHOP DRAWINGS.

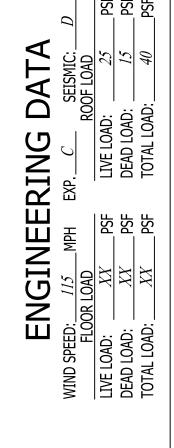

LIST OF DRAWINGS

- TITLE SHEET, PROJECT INFO

 FLOOR PLAN & SECTION
- . ROOF PLAN & SECTION
- FRAMING
- 5. WALL PANEL LAYOUTS
- 6. ROOF PANEL LAYOUTS & PERSPECTIVE
- 7. PBS DETAILS

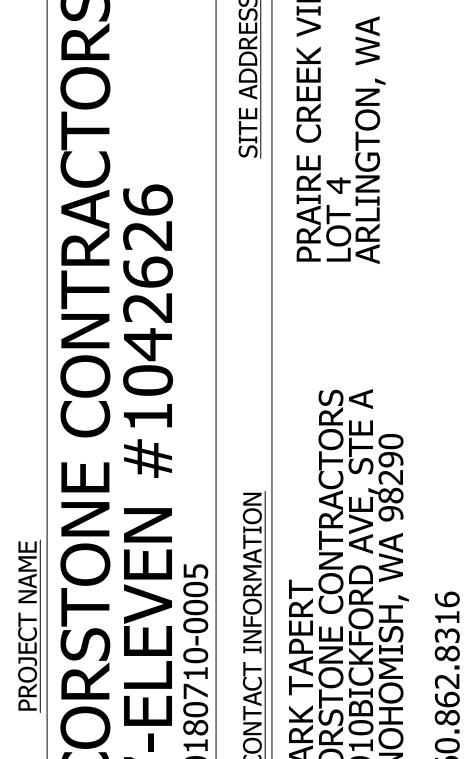

| DRAWN BY: | ROD K | JULY 30, 20 |
|-------------|-------|-------------|
| CHECKED BY: | | |
| | | |

| SIONS: | | |
|---------|-------------------------|--|
| DRAFTER | DATE | TYPE |
| MLK | 8-31-18 | C-REV |
| MLK | 9-13-18 | E-REV |
| MLK | 9-18-18 | FINAL |
| MLK | 9-26-18 | FINAL-REVISED |
| MLK | 9-28-18 | FINAL-REVISED |
| | DRAFTER MLK MLK MLK MLK | DRAFTER DATE MLK 8-31-18 MLK 9-13-18 MLK 9-18-18 MLK 9-26-18 |


AS A SUPPLIER OF MATERIALS ONLY, PREMIER SIPS DOES NOT ASSUME RESPONSIBILITY FOR ERRORS IN DESIGN, ENGINEERING, OR DIMENSIONS. OWNER/AGENT (ARCHITECT, CONTRACTOR, AND/OR INSTALLER) SHALL VERIFY ALL DIMENSIONS AND SIZES, AND BY SIGNING THESE PLANS, THE OWNER TAKES FULL RESPONSIBILITY FOR THEIR ACCURACY.

DELIVERY & STORAGE

IN ORDER TO KEEP YOUR FREIGHT COSTS TO A MINIMUM AND MAKE THE MOST EFFICIENT USE OF THE SPACE AVAILABLE ON A TRUCK, WE TYPICALLY DO NOT SHIP PANELS IN NUMERICAL SEQUENCE. BEAR IN MIND THAT ALL PANELS HAVE MARKINGS WHICH DO MAKE FOR A SMOOTH IDENTIFICATION PROCESS.

HOWEVER, IF YOU DESIRE A SPECIAL LOADING PLAN, THAT REQUEST, AND LAYOUT, MUST BE MADE CONCURRENT WITH THE RETURN OF THE SIGNED SHOP DRAWINGS AND MAY BE SUBJECT TO AN ADDITIONAL FEE. PANELS ARE FABRICATED AT 4' & 8' WIDTHS AND UP TO 24' LENGTHS. 6' FORKS ARE REQUIRED FOR 8' WIDE PANELS (REFER TO THE CONTRACT OF SALE FOR MORE INFORMATION OR ASK PREMIER FOR A DELIVERY INFORMATION SHEET). ALL PANELS SHALL BE STORED IN A PROTECTED AREA AND SUPPORTED EVERY 4' TO PREVENT DEFORMATION AND CONTACT WITH THE GROUND. DO NOT USE A BLACK OR DARK COLORED TARP. PRIOR TO INSTALLATION, ALL PANELS SHALL BE COVERED TO PREVENT CONTACT WITH WATER ON ALL EXPOSED PANEL EDGES.

LEGEND/ABBREVIATIONS

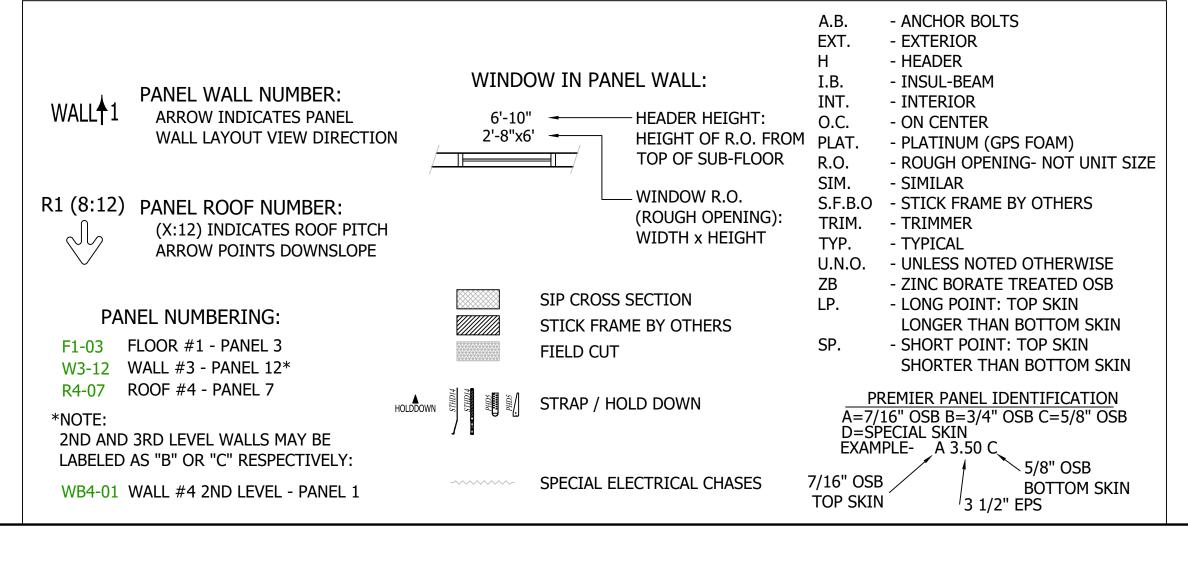

THIS PROJECT UTILIZES THE FOLLOWING PANEL TYPES SIGN H

PREMIER WALL TYPE
A5.50A
R-VALUE = 25

PREMIER ROOF TYPE

PREMIER ROOF TYPE C9.25C R-VALUE = 42.5 SIGN HERE PLEASE

CUSTOMER'S SIGNATURE

CUSTOMER'S REQUESTED DATE OF DELIVERY

REVISE & RESUBMIT

APPROVED WITH REVISIONS AS NOTED IN RED

☐ APPROVED AS DRAWN

NOTES:

- 1. ALL OVERHANG DIMENSIONS ARE TO TOP SKIN OF SIP ROOF PANEL. U.N.O.
- 2. ROUGH OR SMOOTH OSB DOES NOT DENOTE TOP OR BOTTOM OF SIP. REFER TO PANEL LAYOUTS FOR PANEL ORIENTATION.
- 3. ALL IN-PLANE, PANEL-TO-PANEL JOINTS PBS-005 U.N.O
- 4. INSUL-BEAM HEADERS ARE CUT TO 1' INCREMENTS ROUNDED UP FROM THE REQUIRED ROUGH OPENING. (IF YOU'RE ABOUT TO CUT OFF MORE THAN 1' OF INSUL-BEAM THEN YOU'RE CUTTING THE WRONG ONE).
- 5. STANDARD DETAILS PROVIDED FOR TYPICAL INSTALLATION METHODS. REFERENCE ARCHITECTURAL AND STRUCTURAL DRAWINGS FOR JOB SPECIFIC CONNECTION DETAILS, WHICH TAKE PRECEDENT OVER PBS TYPICAL DETAILS.
- 6. FACTORY INSTALLED LUMBER (IF REQUESTED BY CUSTOMER) WILL BE HIGHLIGHTED IN RED IN THE SIP PANEL LAYOUTS
- 7. STANDARD WALL ELECTRICAL CHASES INCLUDED BY DEFAULT. NO ELECTRICAL CHASES IN SIP ROOF PANELS U.N.O.

| Pf | REMIER S | .I.P. PANE | L SHEAR \ | WALL SCH | IEDULE (N | ITA PRS0328 | 08-3) |
|--------|--------------------------------------|--------------------------------------|--------------------------------------|---|--|--------------------|------------|
| MARK | | A | TTACHMENT | S | | ALLOWABLE SHEAR | A35/LTP4 |
| IVIAIN | TOP PLATE | BOTTOM PLATE | VERT FRAMING | SOLE NAILING | SILL ANCHORAGE | (plf) | SPACING |
| A | 8d BOX NAIL @ 6" O.C. | 8d BOX NAIL @ 6" O.C. | 8d BOX NAIL @ 6" O.C. (2 ROWS) | (2) 16d NAILS @ 12" O.C. | 5/8" x 10" A.B. @ 4'-0" O.C. | 250 | 20" O.C. |
| B | 8d BOX NAIL @ 6" O.C. | 8d BOX NAIL @ 6" O.C. | 8d BOX NAIL @ 6" O.C. (2 ROWS) | (2) 16d NAILS @ 12" O.C. | 5/8" x 10" A.B. @ 2'-8" O.C. | 350 | 15" O.C. |
| c | 8d BOX NAIL @ 3" O.C. (2 ROWS) | 8d BOX NAIL @ 3" O.C. (2 ROWS) | 8d BOX NAIL @ 3" O.C. (4 ROWS) | SDS 1/4"x6" @ 5" O.C. W/ 3x PLATE | 5/8" x 12" A.B. @ 1'-6" O.C. W/ 3x PLATE | 720 | 7 1/2" O.C |
| | 8d BOX NAIL @ 2" O.C. (2 ROWS) | 8d BOX NAIL @ 2" O.C. (2 ROWS) | 8d BOX NAIL @ 2" O.C. (4 ROWS) | SDS 1/4"x6" @ 4" O.C. W/ 3x PLATE | 5/8" x 12" A.B. @ 1'-4" O.C. W/ 3x PLATE | 920 | 5 1/2" O.C |

NOTES:

- 1. USE SHEAR WALL TYPE A FOR ALL WALLS NOT NOTED ON PLANS.
- 2. PANEL TYPE MAY BE EITHER L OR S TYPE PANELS W/ MINIMUM OSB FACE THICKNESS OF 7/16"
- 3. FRAMING LUMBER SHALL BE DOUGLAS FIR-LARCH HAVING A SPECIFIC GRAVITY OF 0.50 MINIMUM 4. DOUBLE TOP PLATE IS REQUIRED FOR ALL WALLS REQUIRING (2) ROWS OF TOP PLATE NAILING
- 5. ALL VERTICAL FRAMING SHALL BE DOUBLE STUDS OR 4x NOMINAL FRAMING
- 6. SPLINES ARE 7/16"x3" OSB FOR WALL TYPES A & B AND 3/4"x3" FOR WALL TYPES C & D. 7. ALL ANCHOR BOLTS SHALL BE EMBEDDED PER GENERAL STRUCTURAL NOTES
- 8. A MINIMUM OF (2) ANCHOR BOLTS SHALL BE USED ON EACH SILL PLATE SEGMENT. PROVIDE (1) ANCHOR BOLT
- W/IN 9" OF EACH END OF SEGMENT, AND NOT W/IN 4 1/2" OF END OF PLATE
- 9. PRESSURE TREATED SILL PLATES SHALL BE USED WHEN IN CONTACT WITH CONCRETE OR MASONRY
 10. ALL NUTS ON ANCHOR BOLTS SHALL BE SECURELY FASTENED AGAINST SILL PLATE WITHOUT THE NUT OR THE
- WASHER BEING RECESSED INTO THE PLATE.
 11. ALL NUTS SHALL HAVE 1/4"x3"x3" PLATE WASHERS
- 12. STAGGER ALL NAILS TO AVOID SPLITTING FRAMING MEMBERS

GENERAL SIP PLAN NOTES

A. CONTRACTOR TO VERIFY ALL ON SITE DIMENSIONS PRIOR TO STARTING INSTALLATION OF SIP PANELS. NOTIFY MANUFACTURER IMMEDIATELY IF ACTUAL SITE DIMENSIONS VARY FROM THOSE SHOWN ON THESE DRAWINGS.


B. ANY FIELD MODIFICATION OF THE PANELS SHALL BE IN ACCORDANCE WITH APPROVED PREMIER DETAILS AND GOOD CONSTRUCTION PRACTICES UNLESS OTHERWISE APPROVED BY THE PANEL ENGINEER AND THE ENGINEER OF RECORD FOR THE PROJECT


C. IT IS CONTRACTOR'S SOLE RESPONSIBILITY TO PROPERLY SEAL ALL SIP PANELS AT ALL POTENTIAL LEAK POINTS FOR AIR TO ENTER THE SIP ROOF PANELS FROM THE INTERIOR SPACE & PREVENT ROOF LEAKS.

D. IT IS CONTRACTOR'S SOLE RESPONSIBILITY TO ENSURE PANELS REMAIN DRY DURING THE COURSE OF ERECTION. IF PANELS DO GET WET, CONTRACTOR SHALL BE RESPONSIBLE TO THOROUGHLY DRY PANELS, INCLUDING JOINTS.

E. ENGINEER OF RECORD SHALL REVIEW THESE DRAWINGS TO ENSURE THE PANEL ENGINEERING MEETS ALL REQUIRED DESIGN CRITERIA. LOADING LISTED ON COVER SHEET.

- F. ATTACH ALL WALL PANELS PER SHEAR WALL SCHEDULE MARK 'A', U.N.O.
- G. SEE EOR FRAMING PLANS & DETAILS FOR ALL SUPPORTING FRAMING ELEMENTS AND ALL SHEAR TRANSFER CONNECTIONS.
- H. INSTALL SIP TAPE PER MANUFACTURER'S PUBLISHED RECOMMENDATIONS AT ALL JOINTS
- J. ALL EMBEDDED LUMBER SHALL BE FULL LENGTH WITHIN THE PANEL.
- K. ATTACH ALL ROOF PANELS W/ 8d NAILS @ 6" O.C. TOP & BOTTOM AT ALL JOINTS.
- L. ATTACH ROOF PANELS W/ SIP SCREWS @ 12" O.C. MAX AT ALL SUPPORTS, UNLESS NOTED OTHERWISE

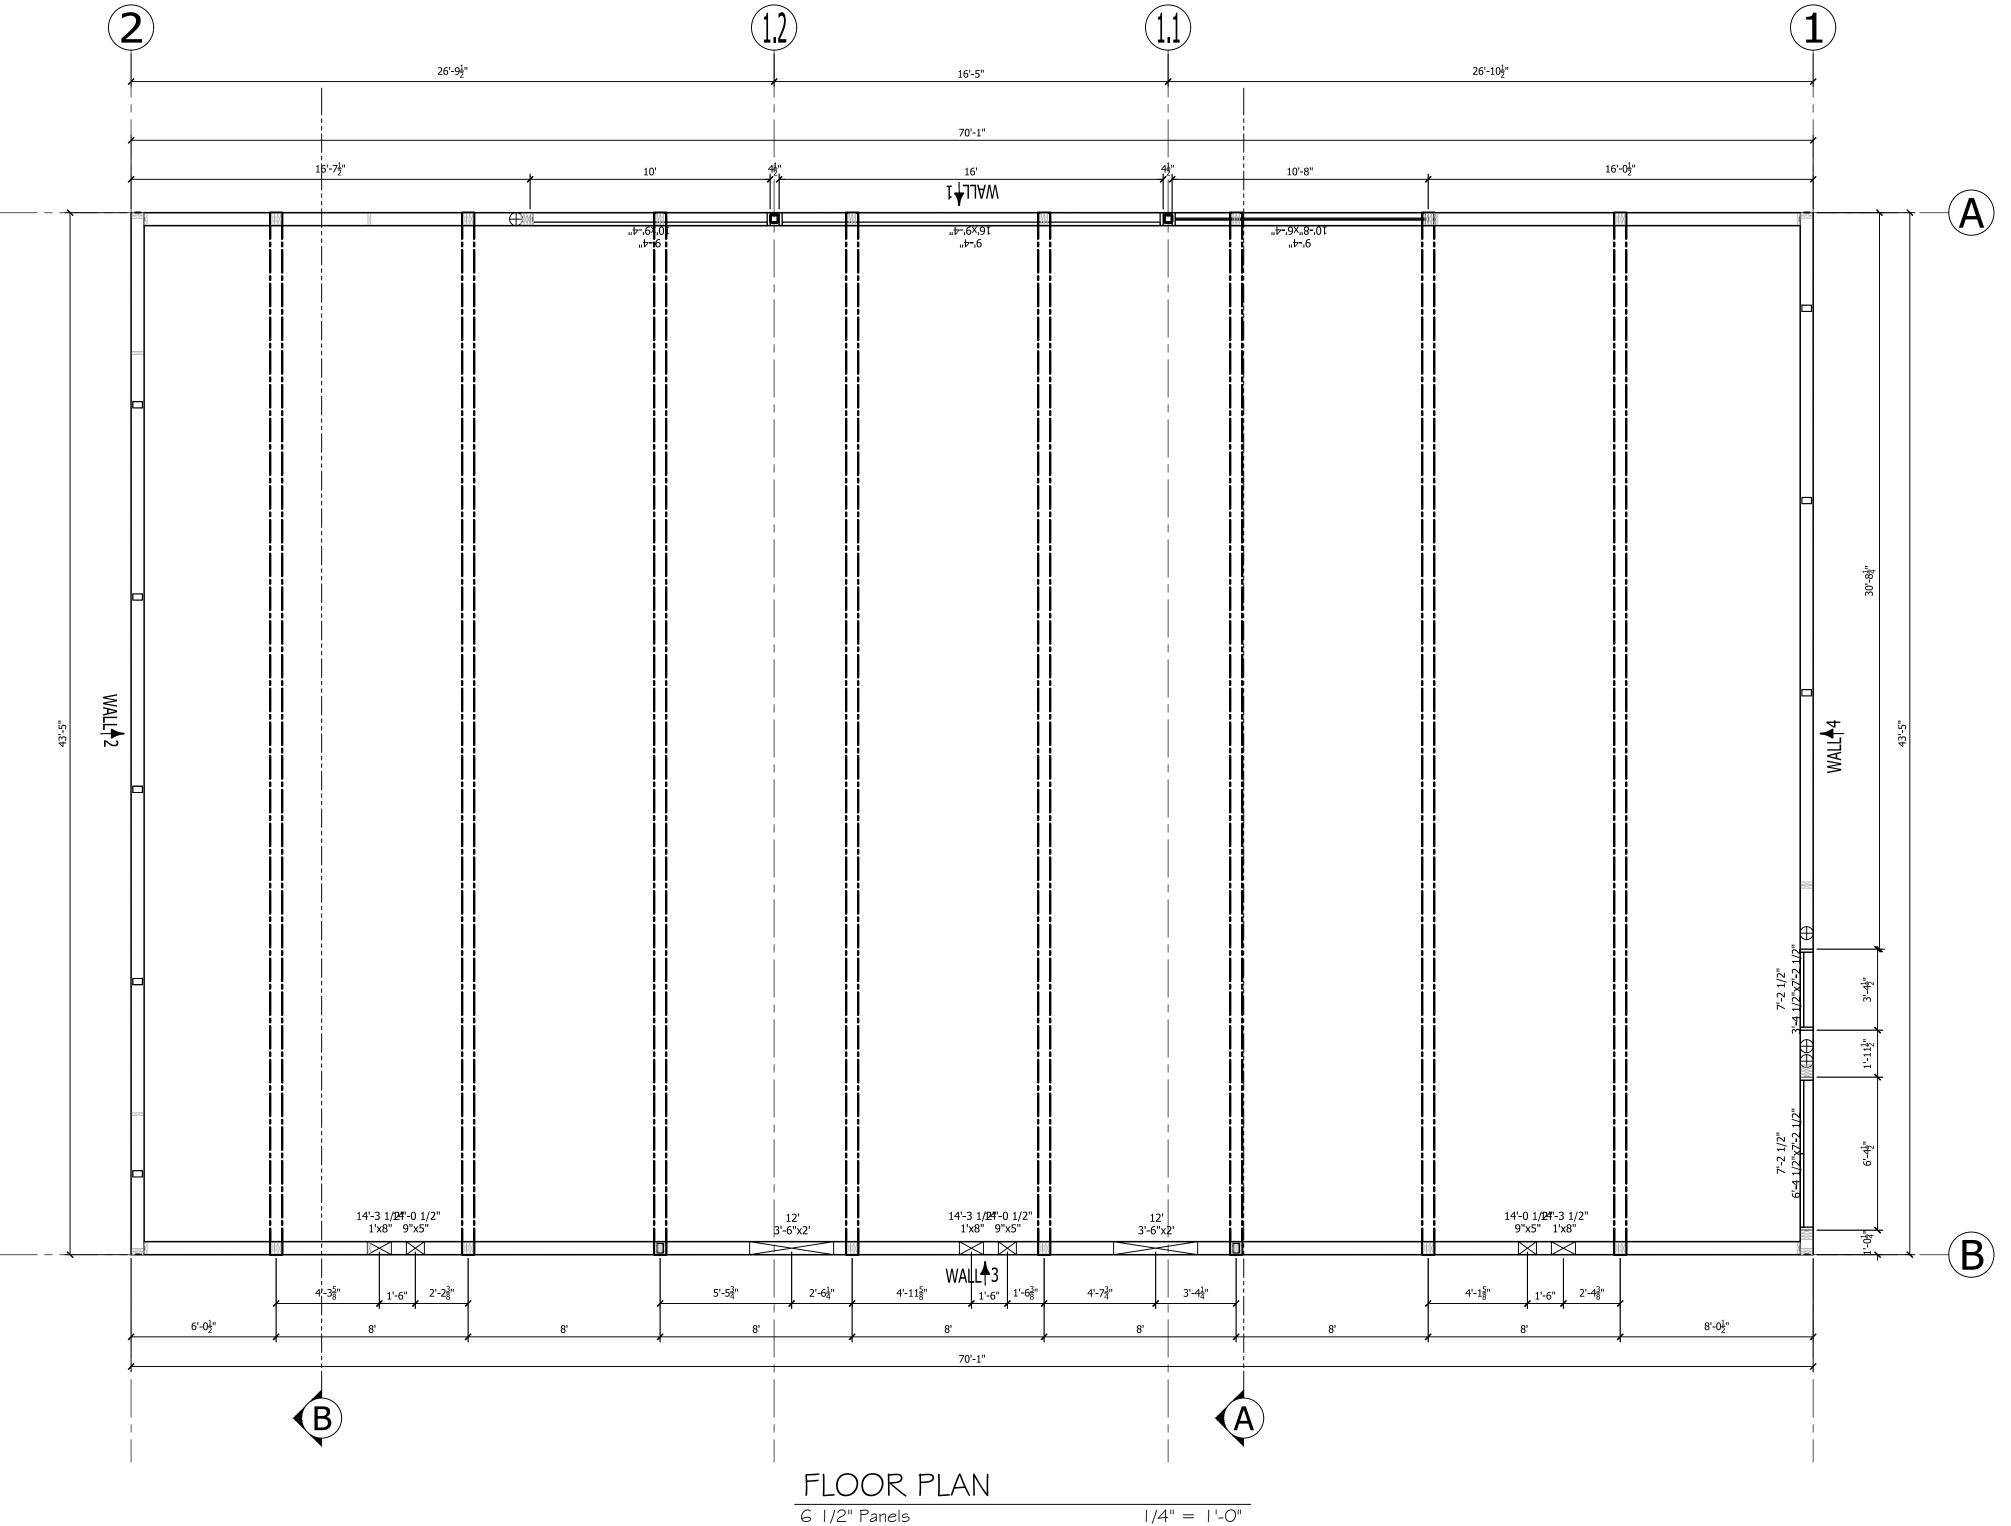

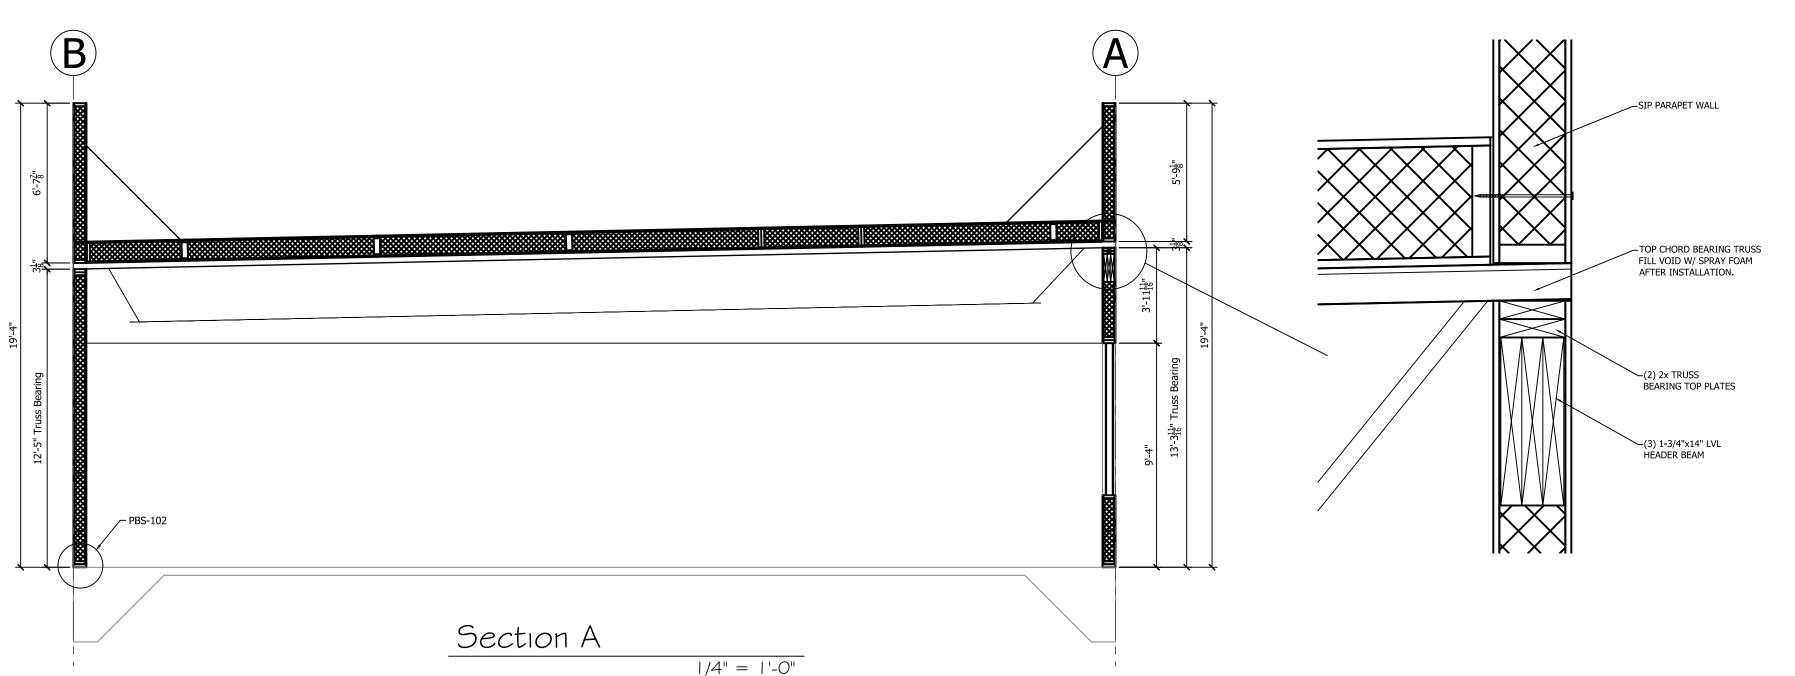

PROJECT INFORMATION:

PROJECT INFORMATION:

CUSTOM

AS A SUPPLIE
NOT ASSUME

AS A SUPPLIE
NOT ASSUME

PROJECT INFORMATION:

AS A SUPPLIE
NOT ASSUME

CUSTOM

AS A SUPPLIE
NOT ASSUME

PROJECT INFORMATION:

AS A SUPPLIE
NOT ASSUME

PROJECT INFORMATION

AS A SUPPLIE
NOT AS A SUPPLIE

2 of 7

18504 Canyon Rd. E.

Puyallup, Wa 98375 800-275-7086

SECTION

٦

FLOOR

- 1. ALL OVERHANG DIMENSIONS ARE TO TOP SKIN OF SIP ROOF PANEL. U.N.O.
- 2. A 1/4" GAP BETWEEN SIP ROOF PANEL AND PARAPET WALL TO ALLOW EASE OF CONSTRUCTION. SPRAY FOAM GAP AROUND PERIMETER AFTER ROOF INSTALLATION.
- 3. ROUGH OR SMOOTH OSB DOES NOT DENOTE TOP OR BOTTOM OF SIP. REFER TO PANEL LAYOUTS FOR PANEL ORIENTATION.
- 4. ALL IN-PLANE, PANEL-TO-PANEL JOINTS PBS-005 U.N.O
- 5. INSUL-BEAM HEADERS ARE CUT TO 1' INCREMENTS ROUNDED UP FROM THE REQUIRED ROUGH OPENING. (IF YOU'RE ABOUT TO CUT OFF MORE THAN 1' OF INSUL-BEAM THEN YOU'RE CUTTING THE WRONG ONE).
- 6. STANDARD DETAILS PROVIDED FOR TYPICAL INSTALLATION METHODS. REFERENCE ARCHITECTURAL AND STRUCTURAL DRAWINGS FOR JOB SPECIFIC CONNECTION DETAILS, WHICH TAKE PRECEDENT OVER PBS TYPICAL DETAILS.
- 7. FACTORY INSTALLED LUMBER (IF REQUESTED BY CUSTOMER) WILL BE HIGHLIGHTED IN RED IN THE SIP PANEL LAYOUTS.
- 8. STANDARD WALL ELECTRICAL CHASES INCLUDED BY DEFAULT. NO ELECTRICAL CHASES IN SIP ROOF PANELS U.N.O.

GENERAL SIP PLAN NOTES

A. CONTRACTOR TO VERIFY ALL ON SITE DIMENSIONS PRIOR TO STARTING INSTALLATION OF SIP PANELS. NOTIFY MANUFACTURER IMMEDIATELY IF ACTUAL SITE DIMENSIONS VARY FROM THOSE SHOWN ON THESE DRAWINGS.

B. ANY FIELD MODIFICATION OF THE PANELS SHALL BE IN ACCORDANCE WITH APPROVED PREMIER DETAILS AND GOOD CONSTRUCTION PRACTICES UNLESS OTHERWISE APPROVED BY THE PANEL ENGINEER AND THE ENGINEER OF RECORD FOR THE PROJECT

C. IT IS CONTRACTOR'S SOLE RESPONSIBILITY TO PROPERLY SEAL ALL SIP PANELS AT ALL POTENTIAL LEAK POINTS FOR AIR TO ENTER THE SIP

D. IT IS CONTRACTOR'S SOLE RESPONSIBILITY TO ENSURE PANELS REMAIN DRY DURING THE COURSE OF ERECTION. IF PANELS DO GET WET, CONTRACTOR SHALL BE RESPONSIBLE TO THOROUGHLY DRY PANELS, INCLUDING JOINTS.

E. ENGINEER OF RECORD SHALL REVIEW THESE DRAWINGS TO ENSURE THE PANEL ENGINEERING MEETS ALL REQUIRED DESIGN CRITERIA. LOADING LISTED ON COVER SHEET.

Section B

1/4" = 1'-0"

F. ATTACH ALL WALL PANELS PER SHEAR WALL SCHEDULE MARK 'A', U.N.O.

ROOF PANELS FROM THE INTERIOR SPACE & PREVENT ROOF LEAKS.


G. SEE EOR FRAMING PLANS & DETAILS FOR ALL SUPPORTING FRAMING ELEMENTS AND ALL SHEAR TRANSFER CONNECTIONS.

H. INSTALL SIP TAPE PER MANUFACTURER'S PUBLISHED RECOMMENDATIONS AT ALL JOINTS

J. ALL EMBEDDED LUMBER SHALL BE FULL LENGTH WITHIN THE PANEL.

K. ATTACH ALL ROOF PANELS W/ 8d NAILS @ 6" O.C. TOP & BOTTOM AT ALL JOINTS.

L. ATTACH ROOF PANELS W/ SIP SCREWS @ 12" O.C. MAX AT ALL SUPPORTS, UNLESS NOTED OTHERWISE

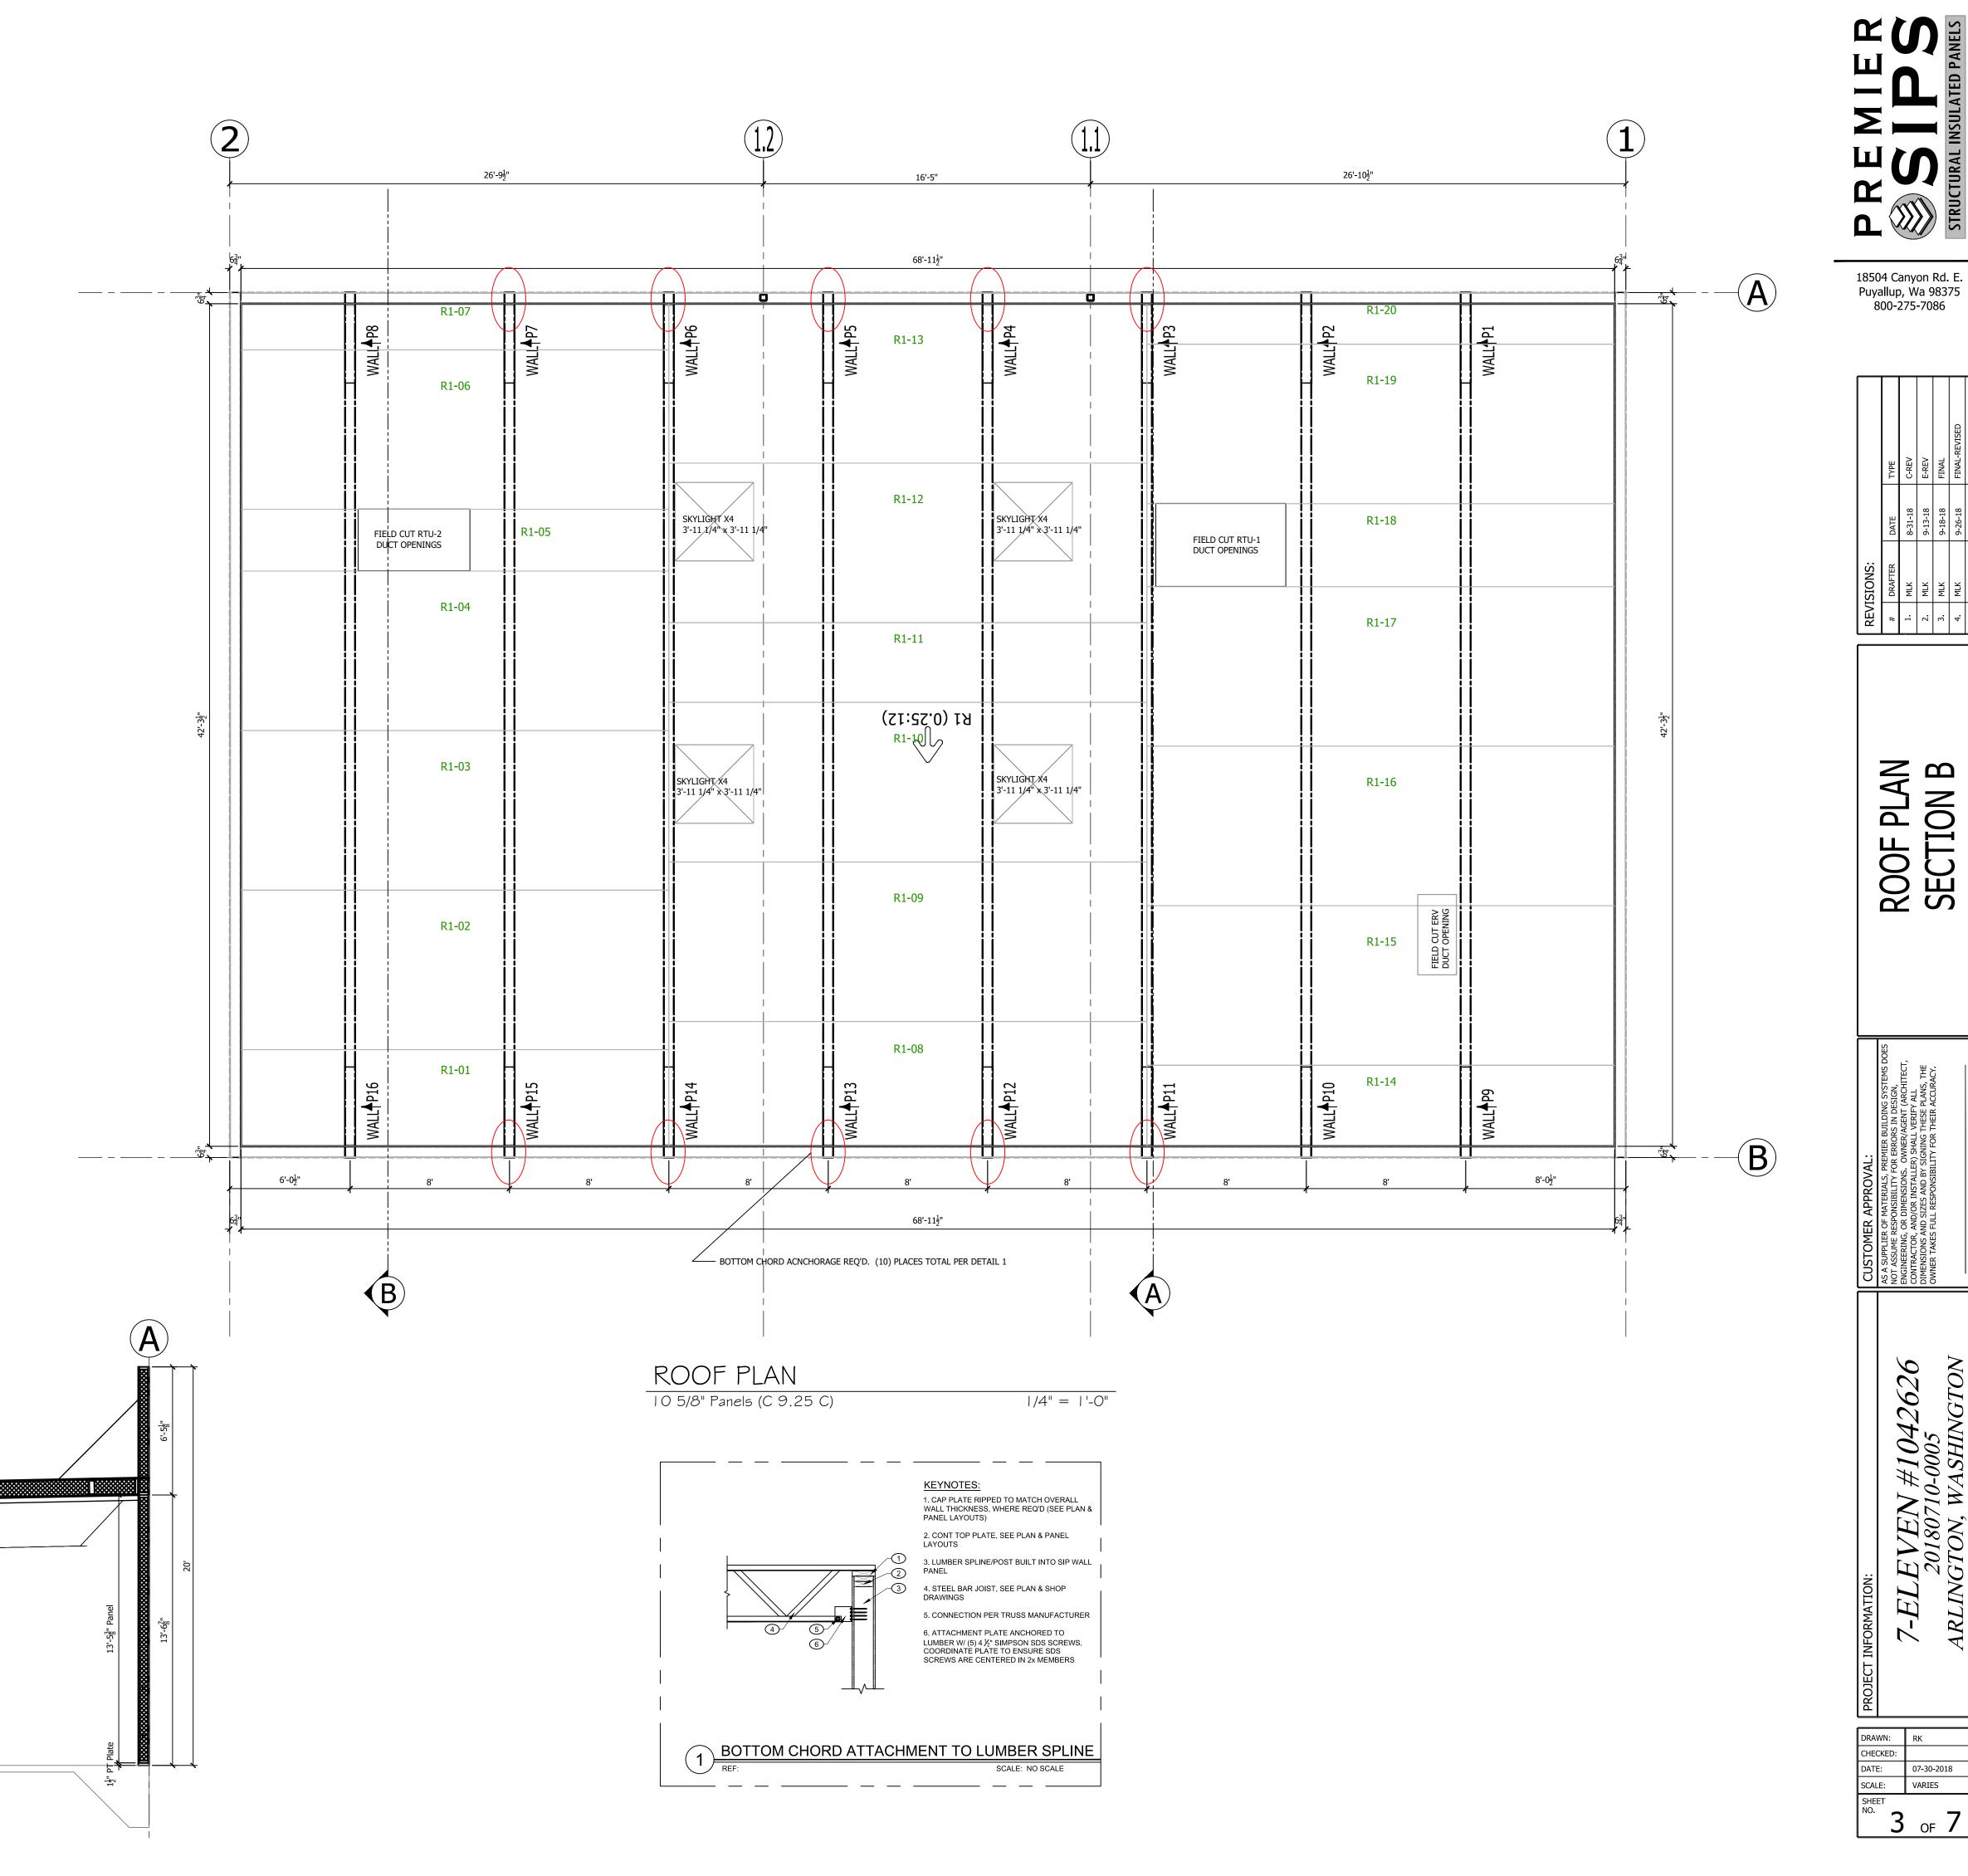

Puyallup, Wa 98375

800-275-7086

DRAIN MLK MLK MLK

CTION

ROOF SECTI

굽


DRAWN:


3 of 7


EVEN #1042626 20180710-0005 GTON, WASHINGTON

7-ELEVE

| RK |
|------------|
| |
| 07-30-2018 |
| VARIES |
| 1 of 7 |
| |

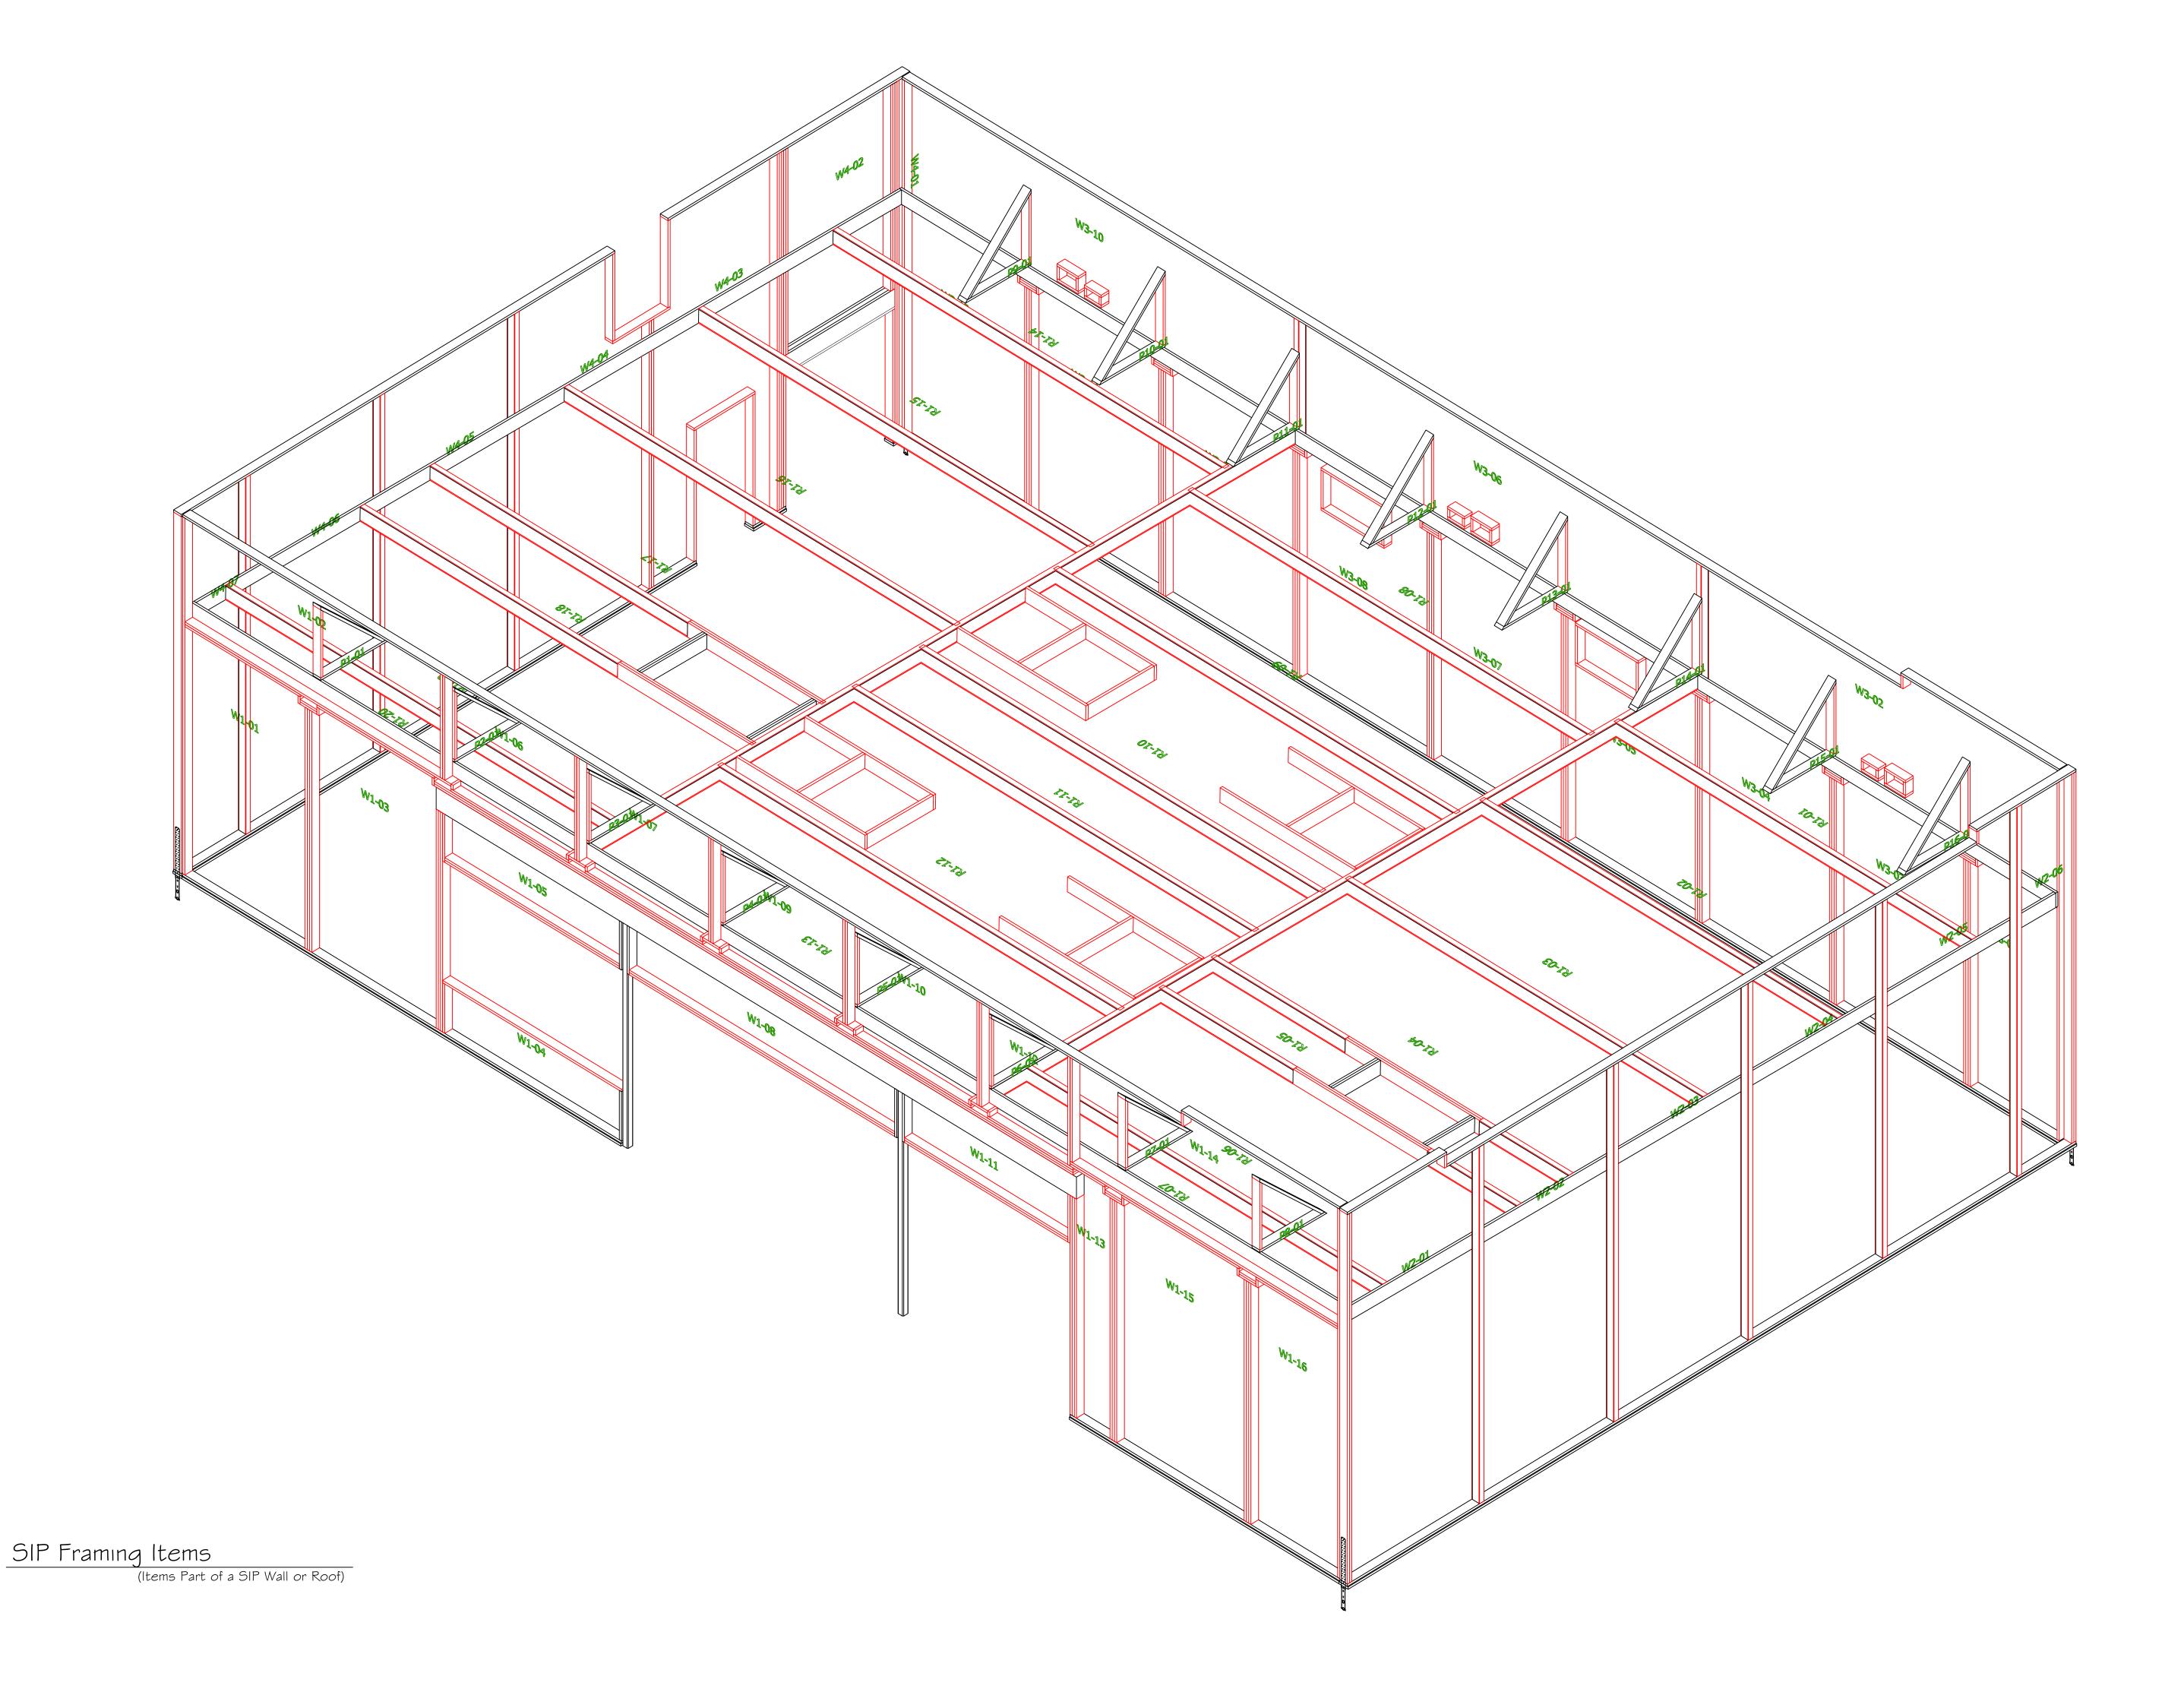

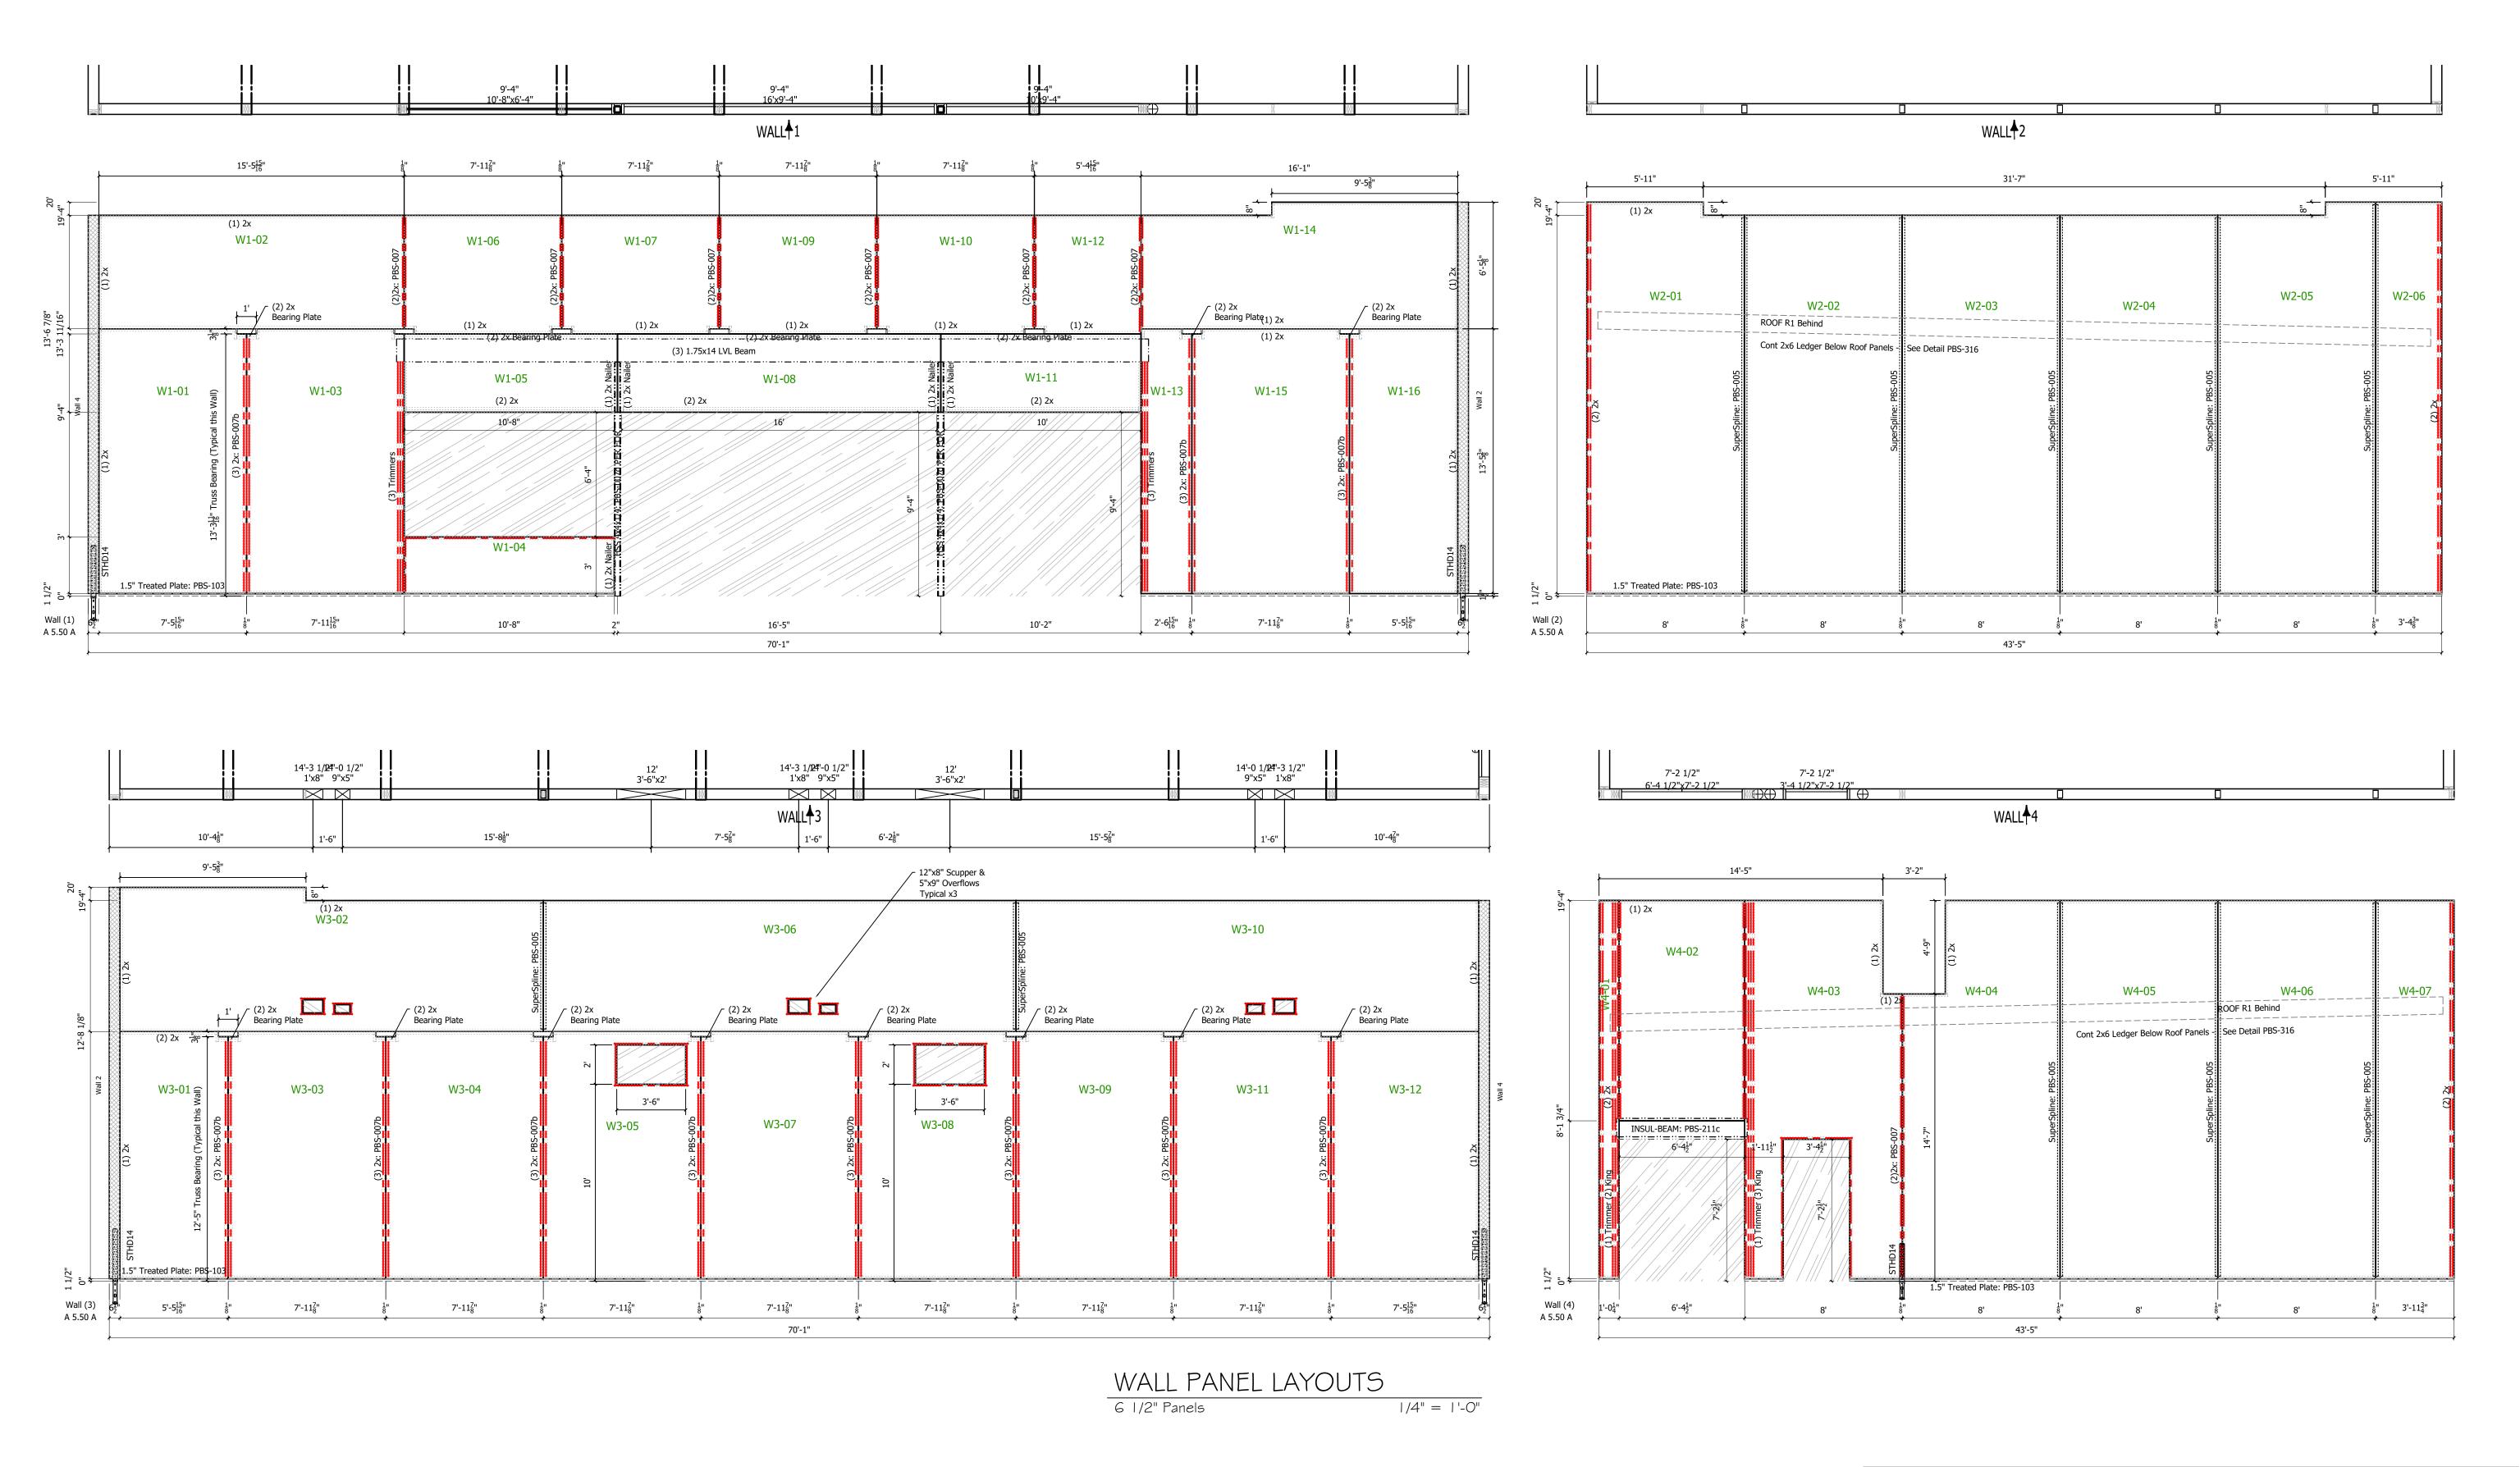

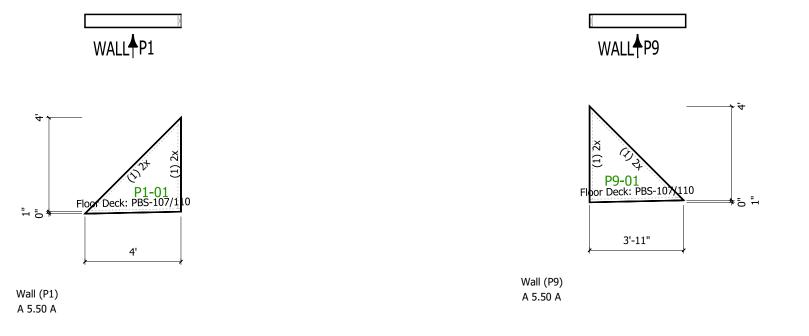

Wall P2-P8 are the same as Wall P1 Wall P10-P16 are the same as Wall P9

Parapet Brace Walls

6 1/2" Panels

1/4" = 1'-0"

OTES:

- 1. ALL OVERHANG DIMENSIONS ARE TO TOP SKIN OF SIP ROOF PANEL. U.N.O.
- 2. A 1/4" GAP BETWEEN SIP ROOF PANEL AND PARAPET WALL TO ALLOW EASE OF CONSTRUCTION. SPRAY FOAM GAP AROUND PERIMETER AFTER ROOF INSTALLATION.
- 3. ROUGH OR SMOOTH OSB DOES NOT DENOTE TOP OR BOTTOM OF SIP. REFER TO PANEL LAYOUTS FOR PANEL ORIENTATION.
- LAYOUTS FOR PANEL ORIENTATION.
 4. ALL IN-PLANE, PANEL-TO-PANEL JOINTS PBS-005 U.N.O
- 5. INSUL-BEAM HEADERS ARE CUT TO 1' INCREMENTS ROUNDED UP FROM THE REQUIRED ROUGH OPENING. (IF YOU'RE ABOUT TO CUT OFF MORE THAN 1' OF INSUL-BEAM THEN YOU'RE CUTTING THE WRONG ONE).
- 6. STANDARD DETAILS PROVIDED FOR TYPICAL INSTALLATION METHODS. REFERENCE ARCHITECTURAL AND STRUCTURAL DRAWINGS FOR JOB SPECIFIC CONNECTION DETAILS, WHICH
- TAKE PRECEDENT OVER PBS TYPICAL DETAILS.

 7. FACTORY INSTALLED LUMBER (IF REQUESTED BY CUSTOMER) WILL BE HIGHLIGHTED IN RED IN THE SIP PANEL LAYOUTS.
- 8. STANDARD WALL ELECTRICAL CHASES INCLUDED BY DEFAULT. NO ELECTRICAL CHASES IN SIP ROOF PANELS U.N.O.

PREMISE NATIONALED PANELS

18504 Canyon Rd. E. Puyallup, Wa 98375 800-275-7086


| REV] | REVISIONS: | | |
|------|------------|---------|---------------|
| # | DRAFTER | DATE | ТҮРЕ |
| 1. | MLK | 8-31-18 | C-REV |
| 2. | MLK | 9-13-18 | E-REV |
| 3. | MLK | 9-18-18 | FINAL |
| 4. | MLK | 9-26-18 | FINAL-REVISED |
| 5. | MLK | 9-28-18 | FINAL-REVISED |
| | | | |

WALL PANEL LAYOUTS

S A SUPPLIER OF MATERIALS, PREMIER BUILDING SYSTEMS DOES OT ASSUME RESPONSIBILITY FOR ERRORS IN DESIGN, VGINERRING, OR DIMENSIONS. OWNER/AGENT (ARCHITECT, ONTRACTOR, AND/OR INSTALLER) SHALL VERIFY ALL IMENSIONS AND SIZES AND BY SIGNING THESE PLANS, THE WINER TAKES FULL RESPONSIBILITY FOR THEIR ACCURACY.

7-ELEVEN #1042626 20180710-0005 ARLINGTON, WASHINGTON

DRAWN: RK
CHECKED:
DATE: 07-30-2018
SCALE: VARIES
SHEET NO. 5 OF 7

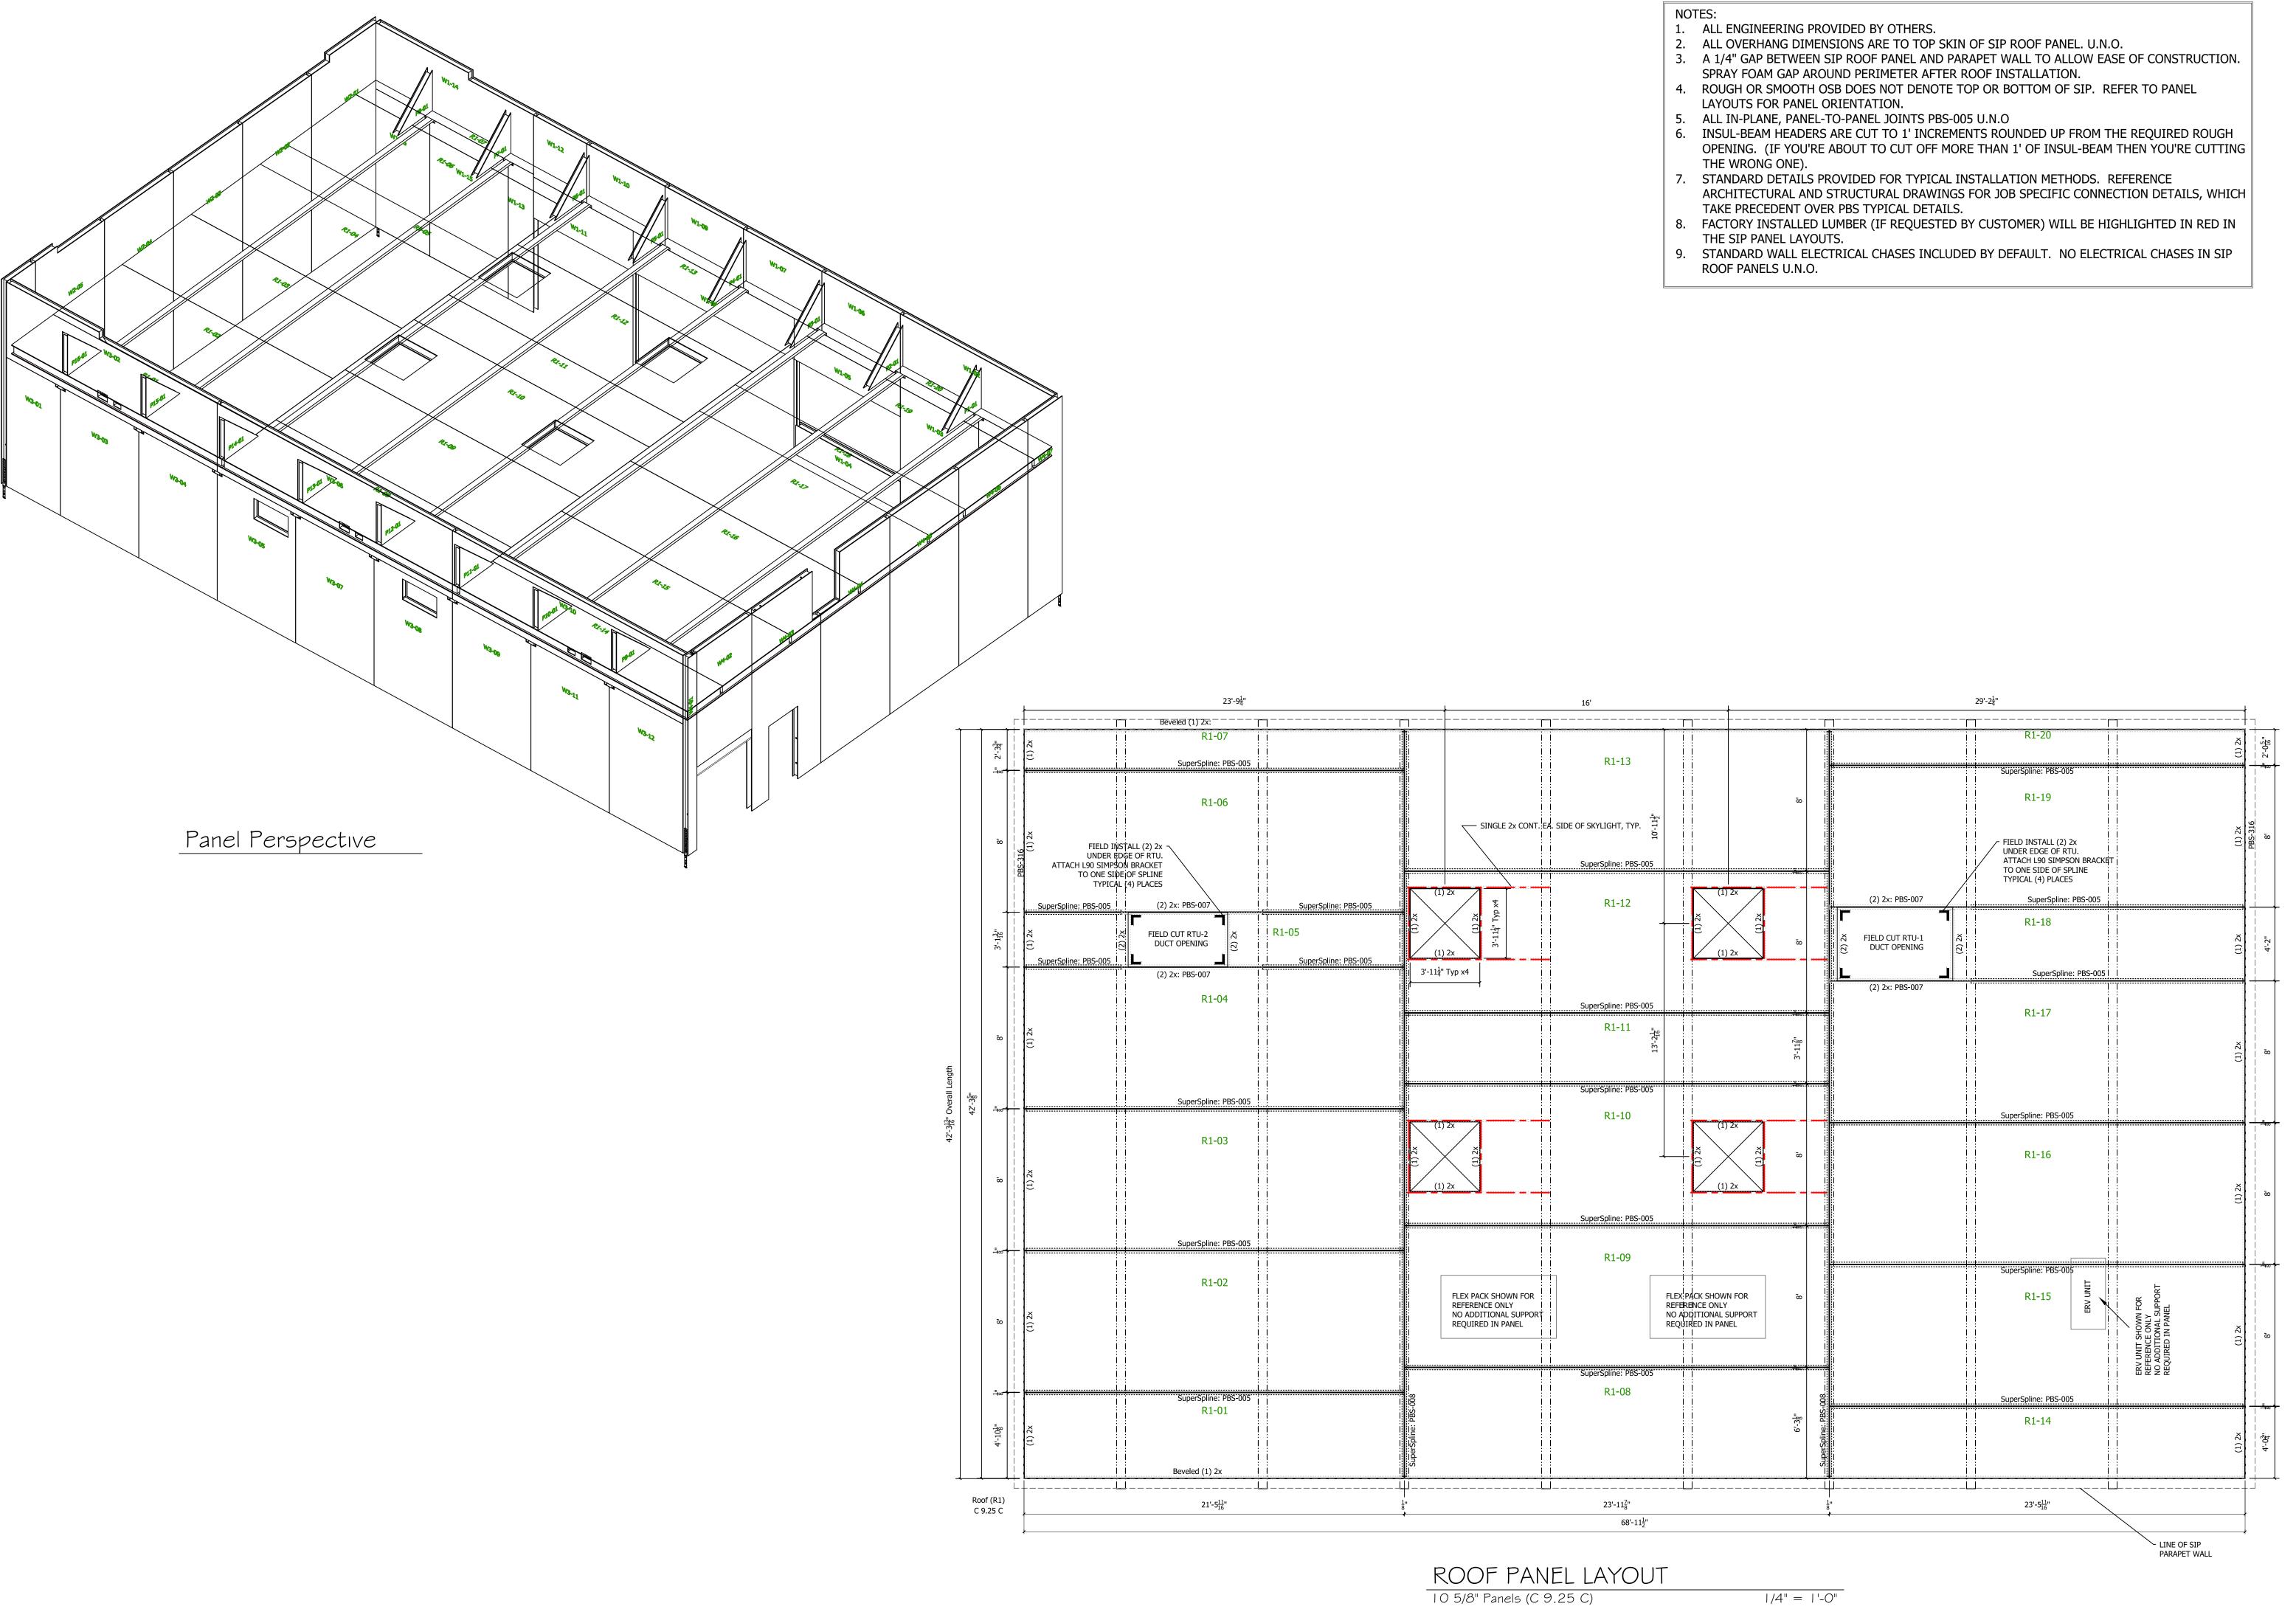

REMIER RUCTURAL INSULATED PANELS

18504 Canyon Rd. E. Puyallup, Wa 98375 800-275-7086

 REVISIONS:

 #
 DRAFTER
 DATE
 TYPE

 1.
 MLK
 8-31-18
 C-REV

 2.
 MLK
 9-13-18
 E-REV

 3.
 MLK
 9-18-18
 FINAL

 4.
 MLK
 9-26-18
 FINAL-REVISED

 5.
 MLK
 9-28-18
 FINAL-REVISED

ROOF PANEL LAYOUT PERSPECTIVE VIEW

CUSTOMER APPROVAL:

AS A SUPPLIER OF MATERIALS, PREMIER BUILDING SYSTEMS DOES NOT ASSUME RESPONSIBILITY FOR ERRORS IN DESIGN, ENGINEERING, OR DIMENSIONS. OWNER/AGENT (ARCHITECT, CONTRACTOR, AND/OR INSTALLER) SHALL VERIFY ALL DIMENSIONS AND SIZES AND BY SIGNING THESE PLANS, THE OWNER TAKES FULL RESPONSIBILITY FOR THEIR ACCURACY.

-ELEVEN #1042626 20180710-0005 RLINGTON, WASHINGTON


N: RK
EED: 07-30-2018

DRAWN: RK
CHECKED:

DATE: 07-30-2018

SCALE: VARIES

SHEET
NO. 6 OF 7

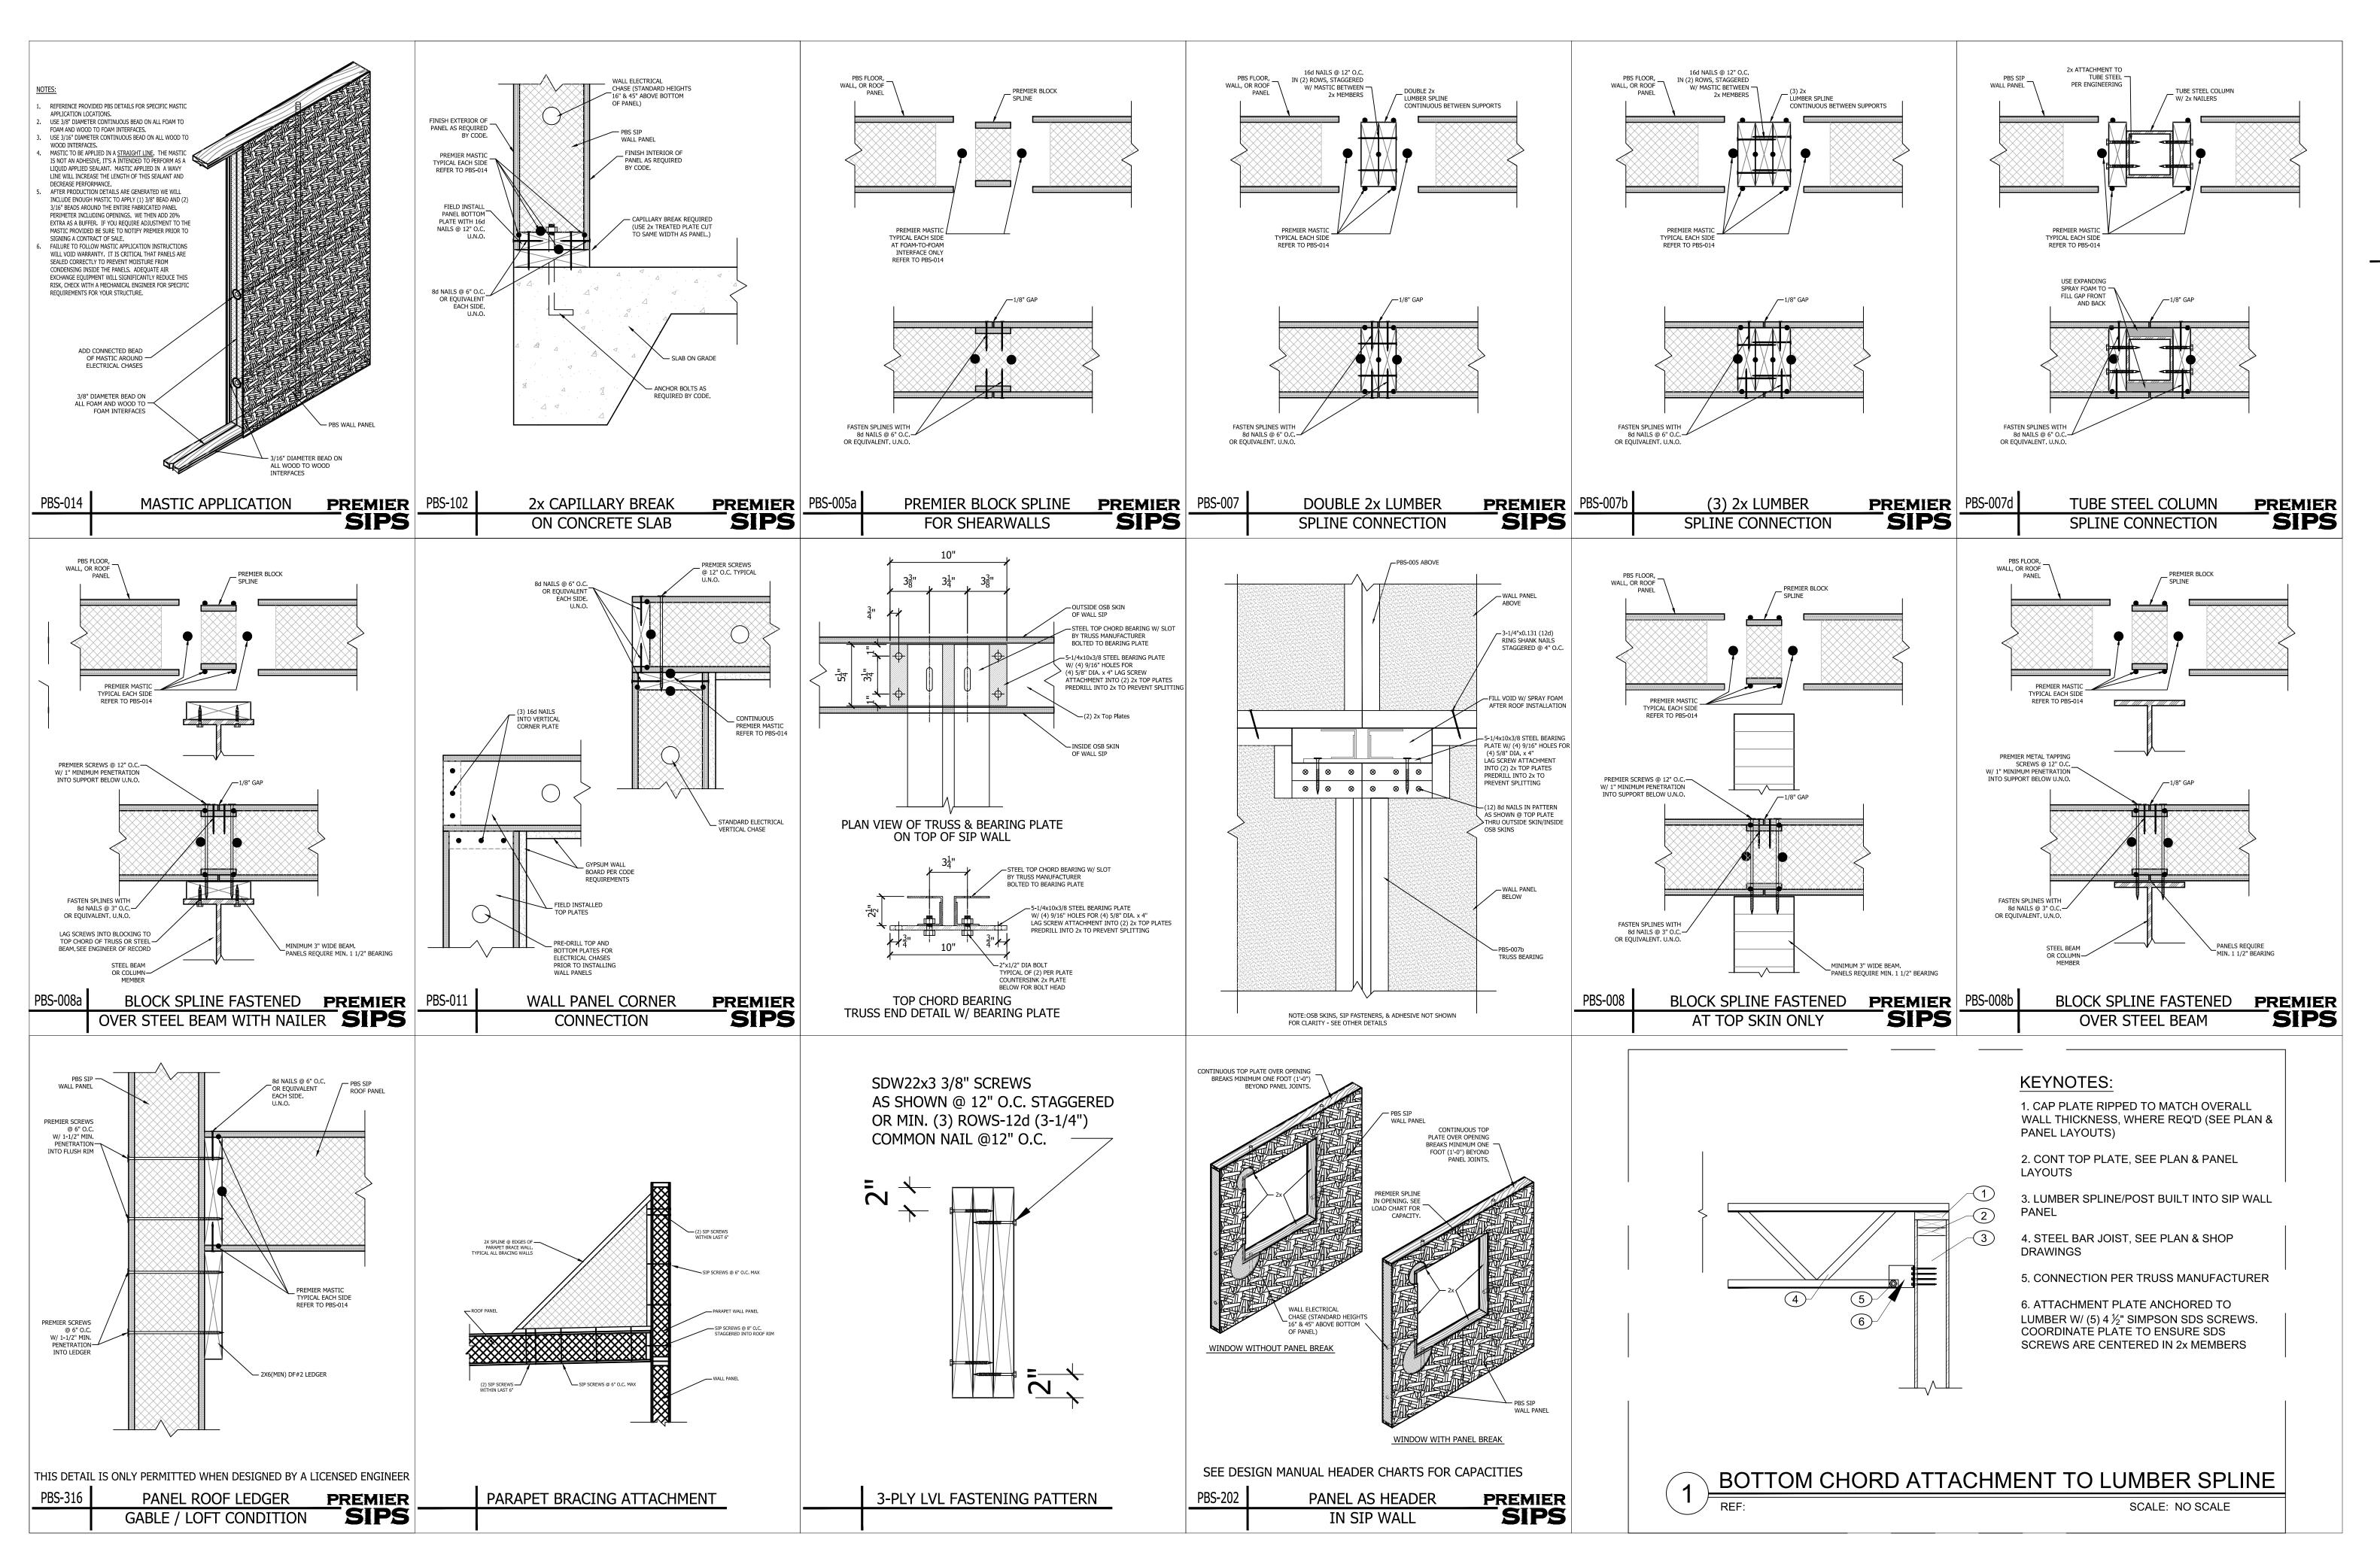

PREMIER STRUCTURAL INSULATED PANELS

18504 Canyon Rd. E. Puyallup, Wa 98375 800-275-7086

 REVISIONS:

 #
 DRAFTER
 DATE
 TYPE

 1.
 MLK
 8-31-18
 C-REV

 2.
 MLK
 9-13-18
 E-REV

 3.
 MLK
 9-18-18
 FINAL

 4.
 MLK
 9-26-18
 FINAL-REVISED

 5.
 MLK
 9-28-18
 FINAL-REVISED

DETAILS

CUSTOMER APPROVAL:

AS A SUPPLIER OF MATERIALS, PREMIER BUILDING SYSTEMS DOES

NOT ASSUME RESPONSIBILITY FOR ERRORS IN DESIGN,
ENGINEERING, OR DIMENSIONS. OWNER/AGENT (ARCHITECT,
CONTRACTOR, AND/OR INSTALLER) SHALL VERIFY ALL
DIMENSIONS AND SIZES AND BY SIGNING THESE PLANS, THE
OWNER TAKES FULL RESPONSIBILITY FOR THEIR ACCURACY.

SIGNATURE

DATE

7-ELEVEN #1042626 20180710-0005 ARLINGTON, WASHINGTON

DRAWN: RK
CHECKED:
DATE: 07-30-2018
SCALE: VARIES
SHEET NO. 7 OF 7