

MANUFACTURING/SALES
PREMIER BUILDING SYSTEMS, LLC.

18504 Canyon Rd E.

PUYALLUP, WA 98375

OFFICE-800.275.7086

NOTES:

WANG CHEN RESIDENCE

GENERAL NOTES

- PREMIER IS A MATERIAL SUPPLIER AND NOT A BUILDER. PROPER INSTALLATION OF OUR PRODUCT SHOULD BE DONE BY A QUALIFIED CONTRACTOR. IT IS THE CONTRACTORS RESPONSIBILITY TO COMPLY WITH ALL APPLICABLE AND LOCAL CODES AND REGULATIONS.
- SHOP DRAWINGS ARE PREMIER'S INTERPRETATION OF THE PLANS PROVIDED. THE CONTRACTOR SHALL REVIEW ALL SHOP DRAWINGS AND VERIFY ALL DIMENSIONS WITH ARCHITECT. PANELS ARE FABRICATED PER THESE SHOP DRAWINGS. ANY DISCREPANCIES OR MISSING ITEMS IN THESE SHOPS SHOULD BE NOTED.
- PREMIER SHOP DRAWINGS ARE TO BE USED IN CONJUNCTION WITH ARCHITECTURAL AND STRUCTURAL DRAWINGS.

 IF ANYTHING IS NOT CLEAR OR THERE ARE QUESTIONS THEY SHOULD BE IMMEDIATELY DIRECTED TO THE ENGINEER OF RECORD.
- 4. CONTRACTOR SHOULD LOOK THROUGH THE PLANS CAREFULLY TO INSURE THAT ALL ASPECTS OF SIP PACKAGE CAN BE CONSTRUCTED THROUGH THEIR PREFERRED MEANS AND METHODS PRIOR TO SIGNING OFF ON THE SHOP DRAWINGS.
- EXECUTION OF WORK FOR SIP PACKAGE MAY REQUIRE COORDINATION WITH OTHER TRADES (I.E. ELECTRICIAN, HVAC, WINDOW/DOOR MANUFACTURER, ETC...). THIS COORDINATION IS THE RESPONSIBILITY OF THE CONTRACTOR.
- 6. WHEN BUILT PROPERLY A SIP BUILDING PROVIDES A TIGHT ENVELOPE. IT IS THE RESPONSIBILITY OF THE CONTRACTOR TO ENSURE THAT THE SIP STRUCTURE IS PROPERLY VENTILATED TO ENSURE PROPER AIR QUALITY AND HUMIDITY LEVELS.
- 7. IT IS THE CONTRACTOR'S SOLE RESPONSIBILITY TO ENSURE THAT ALL SPLINES ARE PROPERLY SEATED INTO THE PANEL RECESSES AND COMPLETELY SEALED WITH MASTIC OR EXPANDING SPRAY FOAM, INCLUDING BUT NOT LIMITED TO SPLINE JOINTS, PENETRATIONS, LIFTING HOLES, ETC. VOIDS BETWEEN SPLINE JOINTS ARE NOT ACCEPTABLE IN A PROPER SIP INSTALLATION.
- 8. THE CONTRACTOR IS RESPONSIBLE TO DETERMINE THE PROPER WEATHER BARRIER (I.E. HOUSE WRAPS, FLASHING, ROOF UNDERLAYMENT, ETC..) TO DRY IN THE BUILDING ENVELOPE.
- 9. SOME DIMENSIONS CAN NOT BE VERIFIED UNTIL CONSTRUCTED. THEREFORE PREMIER TAKES NO RESPONSIBILITY FOR FIELD FABRICATION. SOME FIELD FABRICATED AREAS MAY HAVE BEEN HIGHLIGHTED ON THE DRAWINGS BUT MAY NOT BE LIMITED TO ONLY THOSE AREAS.
- 10. YOU MAY EXPERIENCE DIMENSIONAL VARIANCES FROM THE CONSTRUCTION DRAWINGS AS PANELS ARE ASSEMBLED DUE TO GAPS AT PANEL JOINTS AND ADDITIONAL MISCELLANEOUS CONSTRUCTION VARIABLES SUCH AS FABRICATION TOLERANCES, LUMBER POST THICKNESS VARIANCES, ETC. FIELD CUTTING THE SIPS MAY BE REQUIRED TO ENSURE THAT THE TOTAL WALL OR ROOF ASSEMBLY IS PER THE CONSTRUCTION DRAWINGS. PREMIER WILL ADD GAPS AS INDICATED ON PANEL LAYOUTS BETWEEN PANEL JOINTS IN THE SHOP DRAWINGS (TYPICALLY 1/8" GAP)
- 11. IT IS THE BUILDERS RESPONSIBILITY TO DETERMINE ALL MATERIALS NECESSARY FOR PANEL INSTALLATION. THIS INCLUDES VERIFYING THAT THE MATERIALS PREMIER WILL BE PROVIDING ARE ADEQUATE FOR THE PROJECT AND SOURCE ANY ADDITIONAL MATERIALS REQUIRED FOR PANEL INSTALLATION THAT ARE NOT PROVIDED BY PREMIER.
- SOURCE ANY ADDITIONAL MATERIALS REQUIRED FOR PANEL INSTALLATION THAT ARE NOT PROVIDED BY PREMIER.

 12. PANEL WALL AND/OR ROOF LAYOUTS INCLUDE LOCATIONS OF FACTORY ELECTRICAL CHASES AS INDICATED IN THE LEGEND BELOW. ADDITIONAL "CUSTOM" ELECTRICAL CHASES MAY BE ADDED FOR A FEE.


REVIEWING PANEL LAYOUT DRAWINGS

TWO ROUNDS OF REVISIONS/EDITS ARE INCLUDED IN THE INITIAL PRE-PRODUCTION SERVICES PORTION OF THE PBS ESTIMATE. ADDITIONAL REVISIONS MAY INCUR ADDITIONAL FEES.

WHEN REVIEWING SHOP DRAWINGS, BEGIN BY CHECKING ALL OF THE OVERALL DIMENSIONS OF THE PROJECT. IF THE PROJECT HAS FLOOR PANELS, PLEASE CHECK POINT LOAD LOCATIONS FOR SOLID BLOCKING AND MAKE SURE ANY OPENINGS OR STEP DOWNS ARE CORRECT. AFTER THE FLOORS HAVE BEEN COMPLETELY CHECKED, MOVE TO THE WALLS. THE WALLS WILL BE SHOWN ON A KEYED FLOOR PLAN WITH WALL NUMBERS CALLED OUT AND AN ARROW POINTING THE VIEW DIRECTION OF EACH OF THE PANEL WALL LAYOUTS. THESE NUMBERS AND THEIR ORIENTATION WILL ALSO BE LOCATED BELOW EVERY PANELIZED WALL. OBSERVE THE LOCATION OF THE PANEL CORNER LAPS. SOME OF THE WALLS WILL BE SHORTER DUE TO CORNER LAPS AND TO THE PANEL THICKNESS. AFTER YOU HAVE MADE SURE ALL DIMENSIONS MATCH YOUR ARCHITECTURAL PLANS, MOVE TO THE WINDOWS AND DOORS. MAKE SURE THAT THE ROUGH OPENINGS FOR THE WINDOWS AND DOORS ARE THE CORRECT SIZE AND ARE LOCATED PROPERLY. IF THE ROOF FOR THE PROJECT IS ALSO PANELS, CHECK THE ROOF PITCH, RIDGE LOCATION, AND THE OVERHANGS AT THE EAVES AND GABLES. EVEN IF THE ROOF IS A SYSTEM OTHER THAN PANELS, GABLE WALL HEIGHTS MAY BE DEPENDENT ON HEEL HEIGHTS OR BE NOTCHED FOR LOOK OUT SUPPORTS. IF THERE ARE SKYLIGHTS CHECK THE ROUGH OPENINGS FOR CORRECT SIZE AND LOCATION. PANEL DRAWINGS ARE TO BE REVIEWED BY OWNER/AGENT AND APPROVED BY OWNER, CONFIRMING ALL DIMENSIONS. OWNER IS RESPONSIBLE FOR VERIFYING ALL PANEL DRAWING DIMENSIONS TO ENSURE PROPER ASSEMBLY. CHECK CORRECT DIMENSIONS AND CLOUD CHANGED DIMENSIONS WITH AN APPROPRIATE ARROW REFERENCING THE DIRECTION OF CHANGE. UNCHECKED DIMENSIONS MAY RESULT IN FIELD FABRICATION.


WHEN YOU HAVE FINISHED VERIFYING THE SHOP DRAWINGS AND HAVE MADE ANY CHANGES/CORRECTIONS, COPY THOSE CHANGES TO THE SHOP DRAWINGS AND SEND BACK TO PREMIER FOR REVISIONS.

ANY AND ALL DISCREPANCIES RELATED TO PANELS ON SITE ARE THE RESPONSIBILITY OF OWNER UNLESS THERE IS A DIFFERENCE BETWEEN FABRICATED PANELS AND SIGNED SHOP DRAWINGS. PREMIER HOLDS FIRST RIGHT OF DECISION TO REPLACE, REPAIR OR PAY FOR REPAIR OF ALL PRODUCTS IN DISCREPANCY WITH FINAL SHOP DRAWINGS.

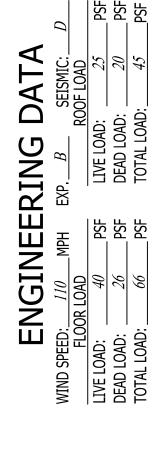

LIST OF DRAWINGS

- 1. TITLE SHEET, PROJECT INFO 2. OVERALL FLOOR PLAN
- MAIN LEVEL FLOOR PLAN
- 4. UPPER LEVEL FLOOR PLAN
- . MAIN LEVEL FLOOR PLAN WEST . MAIN LEVEL FLOOR PLAN - EAST
- . UPPER LEVEL FLOOR PLAN WEST
- UPPER LEVEL FLOOR PLAN EAST
 BUILDING SECTIONS
- 10. PANEL WALL LAYOUTS
- 11. PANEL WALL LAYOUTS
- 12. PANEL WALL LAYOUTS
- 13. PANEL WALL LAYOUTS GARAGE14. COTTAGE FLOOR PLAN & LAYOUTS
- 15. MAIN LEVEL PANEL PERSPECTIVE
- 16. UPPER LEVEL PANEL PERSPECTIVE
- 17. PBS DETAILS
- 18. PBS DETAILS

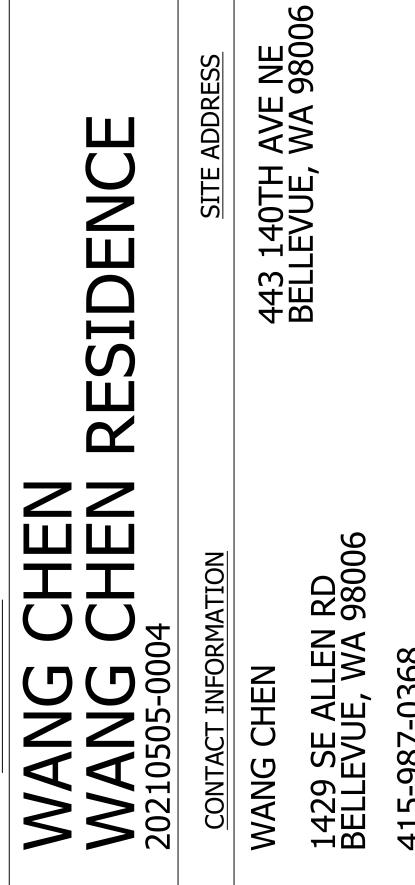

DRAFTER DATE TYPE

1. RKS 03/29/22 E-REV

2. 3.

JANUARY 28,2022

RYAN STOWERS

AS A SUPPLIER OF MATERIALS ONLY, PREMIER SIPS DOES NOT ASSUME RESPONSIBILITY FOR ERRORS IN DESIGN, ENGINEERING, OR DIMENSIONS. OWNER/AGENT (ARCHITECT, CONTRACTOR, AND/OR INSTALLER) SHALL VERIFY ALL DIMENSIONS AND SIZES, AND BY SIGNING THESE PLANS, THE OWNER TAKES FULL RESPONSIBILITY FOR THEIR ACCURACY.


DRAWN BY:

DELIVERY & STORAGE

IN ORDER TO KEEP YOUR FREIGHT COSTS TO A MINIMUM AND MAKE THE MOST EFFICIENT USE OF THE SPACE AVAILABLE ON A TRUCK, WE TYPICALLY DO NOT SHIP PANELS IN NUMERICAL SEQUENCE. BEAR IN MIND THAT ALL PANELS HAVE MARKINGS WHICH DO MAKE FOR A SMOOTH IDENTIFICATION PROCESS.

HOWEVER, IF YOU DESIRE A SPECIAL LOADING PLAN, THAT REQUEST, AND LAYOUT, MUST BE MADE CONCURRENT WITH THE RETURN OF THE SIGNED SHOP DRAWINGS AND MAY BE SUBJECT TO AN ADDITIONAL FEE. PANELS ARE FABRICATED AT 4' & 8' WIDTHS AND UP TO 24' LENGTHS. 6' FORKS ARE REQUIRED FOR 8' WIDE PANELS (REFER TO THE CONTRACT OF SALE FOR MORE INFORMATION OR ASK PREMIER FOR A DELIVERY INFORMATION SHEET). ALL PANELS SHALL BE STORED IN A PROTECTED AREA AND SUPPORTED EVERY 4' TO PREVENT DEFORMATION AND CONTACT WITH THE GROUND. DO NOT USE A BLACK OR DARK COLORED TARP. PRIOR TO INSTALLATION, ALL PANELS SHALL BE COVERED TO PREVENT CONTACT WITH WATER ON ALL EXPOSED PANEL EDGES.

LEGEND/ABBREVIATIONS

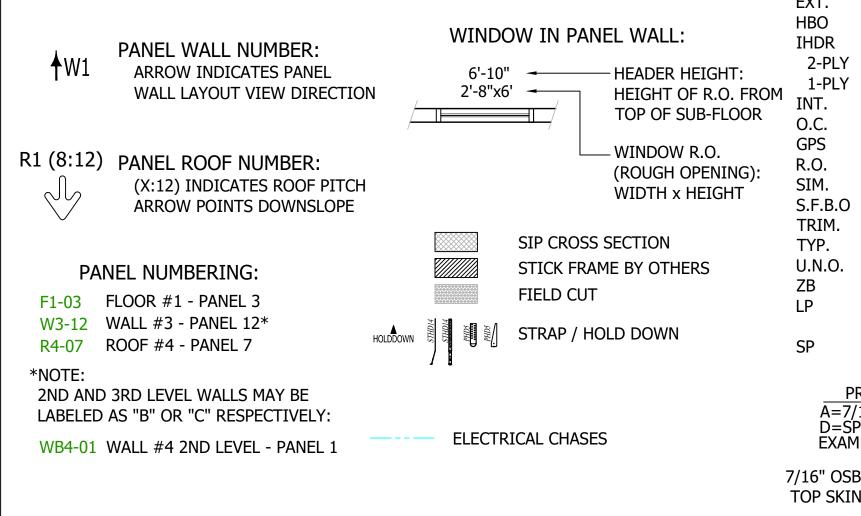

	A.B.	- ANCHOR BOLTS
	EXT.	- EXTERIOR
	HBO	- HEADER BY OTHERS
	IHDR	- INSULATED HEADER
	2-PLY	- (2) 1.75x11.25 LVL
ΩM.	1-PLY	- (1) 1.75x11.25 LVL
MC	INT.	- INTERIOR
•	O.C.	- ON CENTER
	GPS	- GRAPHITE INFUSED EPS FOAM
	R.O.	- ROUGH OPENING- NOT UNIT SIZE
	SIM.	- SIMILAR
		- STICK FRAME BY OTHERS
		- TRIMMER
		- TYPICAL
		- UNLESS NOTED OTHERWISE
		- ZINC BORATE TREATED OSB
	LP	- LONG POINT: TOP SKIN
		LONGER THAN BOTTOM SKIN
	SP	- SHORT POINT: TOP SKIN
		SHORTER THAN BOTTOM SKIN
		REMIER PANEL IDENTIFICATION
	A=7/	16" OSB B=3/4" OSB C=5/8" OSB
	D=SF FYAM	PECIAL SKIN PLE- A 3.50 C
	LAAII	5/8" OSB
7	7/16" OSE	BOTTOM SKIN
	TOP SKIN	3 1/2" EPS
		•


THIS PROJECT UTILIZES THE FOLLOWING PANEL TYPES

WING PANEL TYPES) (SIGN
PREMIER WALL TYPE		PLE/
A5.50A ZB	1	

PLEASE	
	CUS


<i></i>	
CUSTOMER'S SIGNATURE	DATE
☐ REVISE & RESUBMIT	
LINEVISE & NESODITI	
☐ APPROVED WITH REVISIONS	AS NOTED IN RED
APPROVED AS DRAWN	

- 1. SIP WALLS ARE ALIGNED TO STRUCTURAL GRID.
- ALL ENGINEERING PROVIDED BY OTHERS.
- 3. ROUGH OR SMOOTH OSB DOES NOT DENOTE TOP OR BOTTOM OF SIP. REFER TO PANEL LAYOUTS FOR PANEL ORIENTATION.
- 4. ALL IN-PLANE, PANEL-TO-PANEL JOINTS PBS-005 U.N.O
- 5. INSULATED HEADERS (IHDR-2 PLY OR IHDR-1 PLY) ARE CUT TO 1' INCREMENTS ROUNDED UP FROM THE REQUIRED ROUGH OPENING. (IF YOU'RE ABOUT TO CUT OFF MORE THAN 1' OF INSULATED HEADER THEN YOU'RE CUTTING THE WRONG ONE).
- 6. SIP TAPE PROVIDED FOR WALL CONNECTIONS ONLY.
- 7. STANDARD DETAILS PROVIDED FOR TYPICAL INSTALLATION METHODS. REFERENCE ARCHITECTURAL AND STRUCTURAL DRAWINGS FOR JOB SPECIFIC CONNECTION DETAILS, WHICH TAKE PRECEDENT OVER PBS TYPICAL DETAILS.
- 8. BEAM POCKETS TO BE FIELD CUT FOR PROPER ELEVATION AND SIZE.
- 9. FACTORY INSTALLED LUMBER (IF REQUESTED BY CUSTOMER) WILL BE HIGHLIGHTED IN RED IN THE SIP PANEL LAYOUTS.
- 10. STANDARD WALL ELECTRICAL CHASES INCLUDED BY DEFAULT. HORIZONTAL CHASES ARE 16" AND 45" ABOVE BOTTOM OF PANEL AND VERTICALLY APPROXIMATELY 4'-0" O.C DEPENDING ON PANEL WIDTHS.

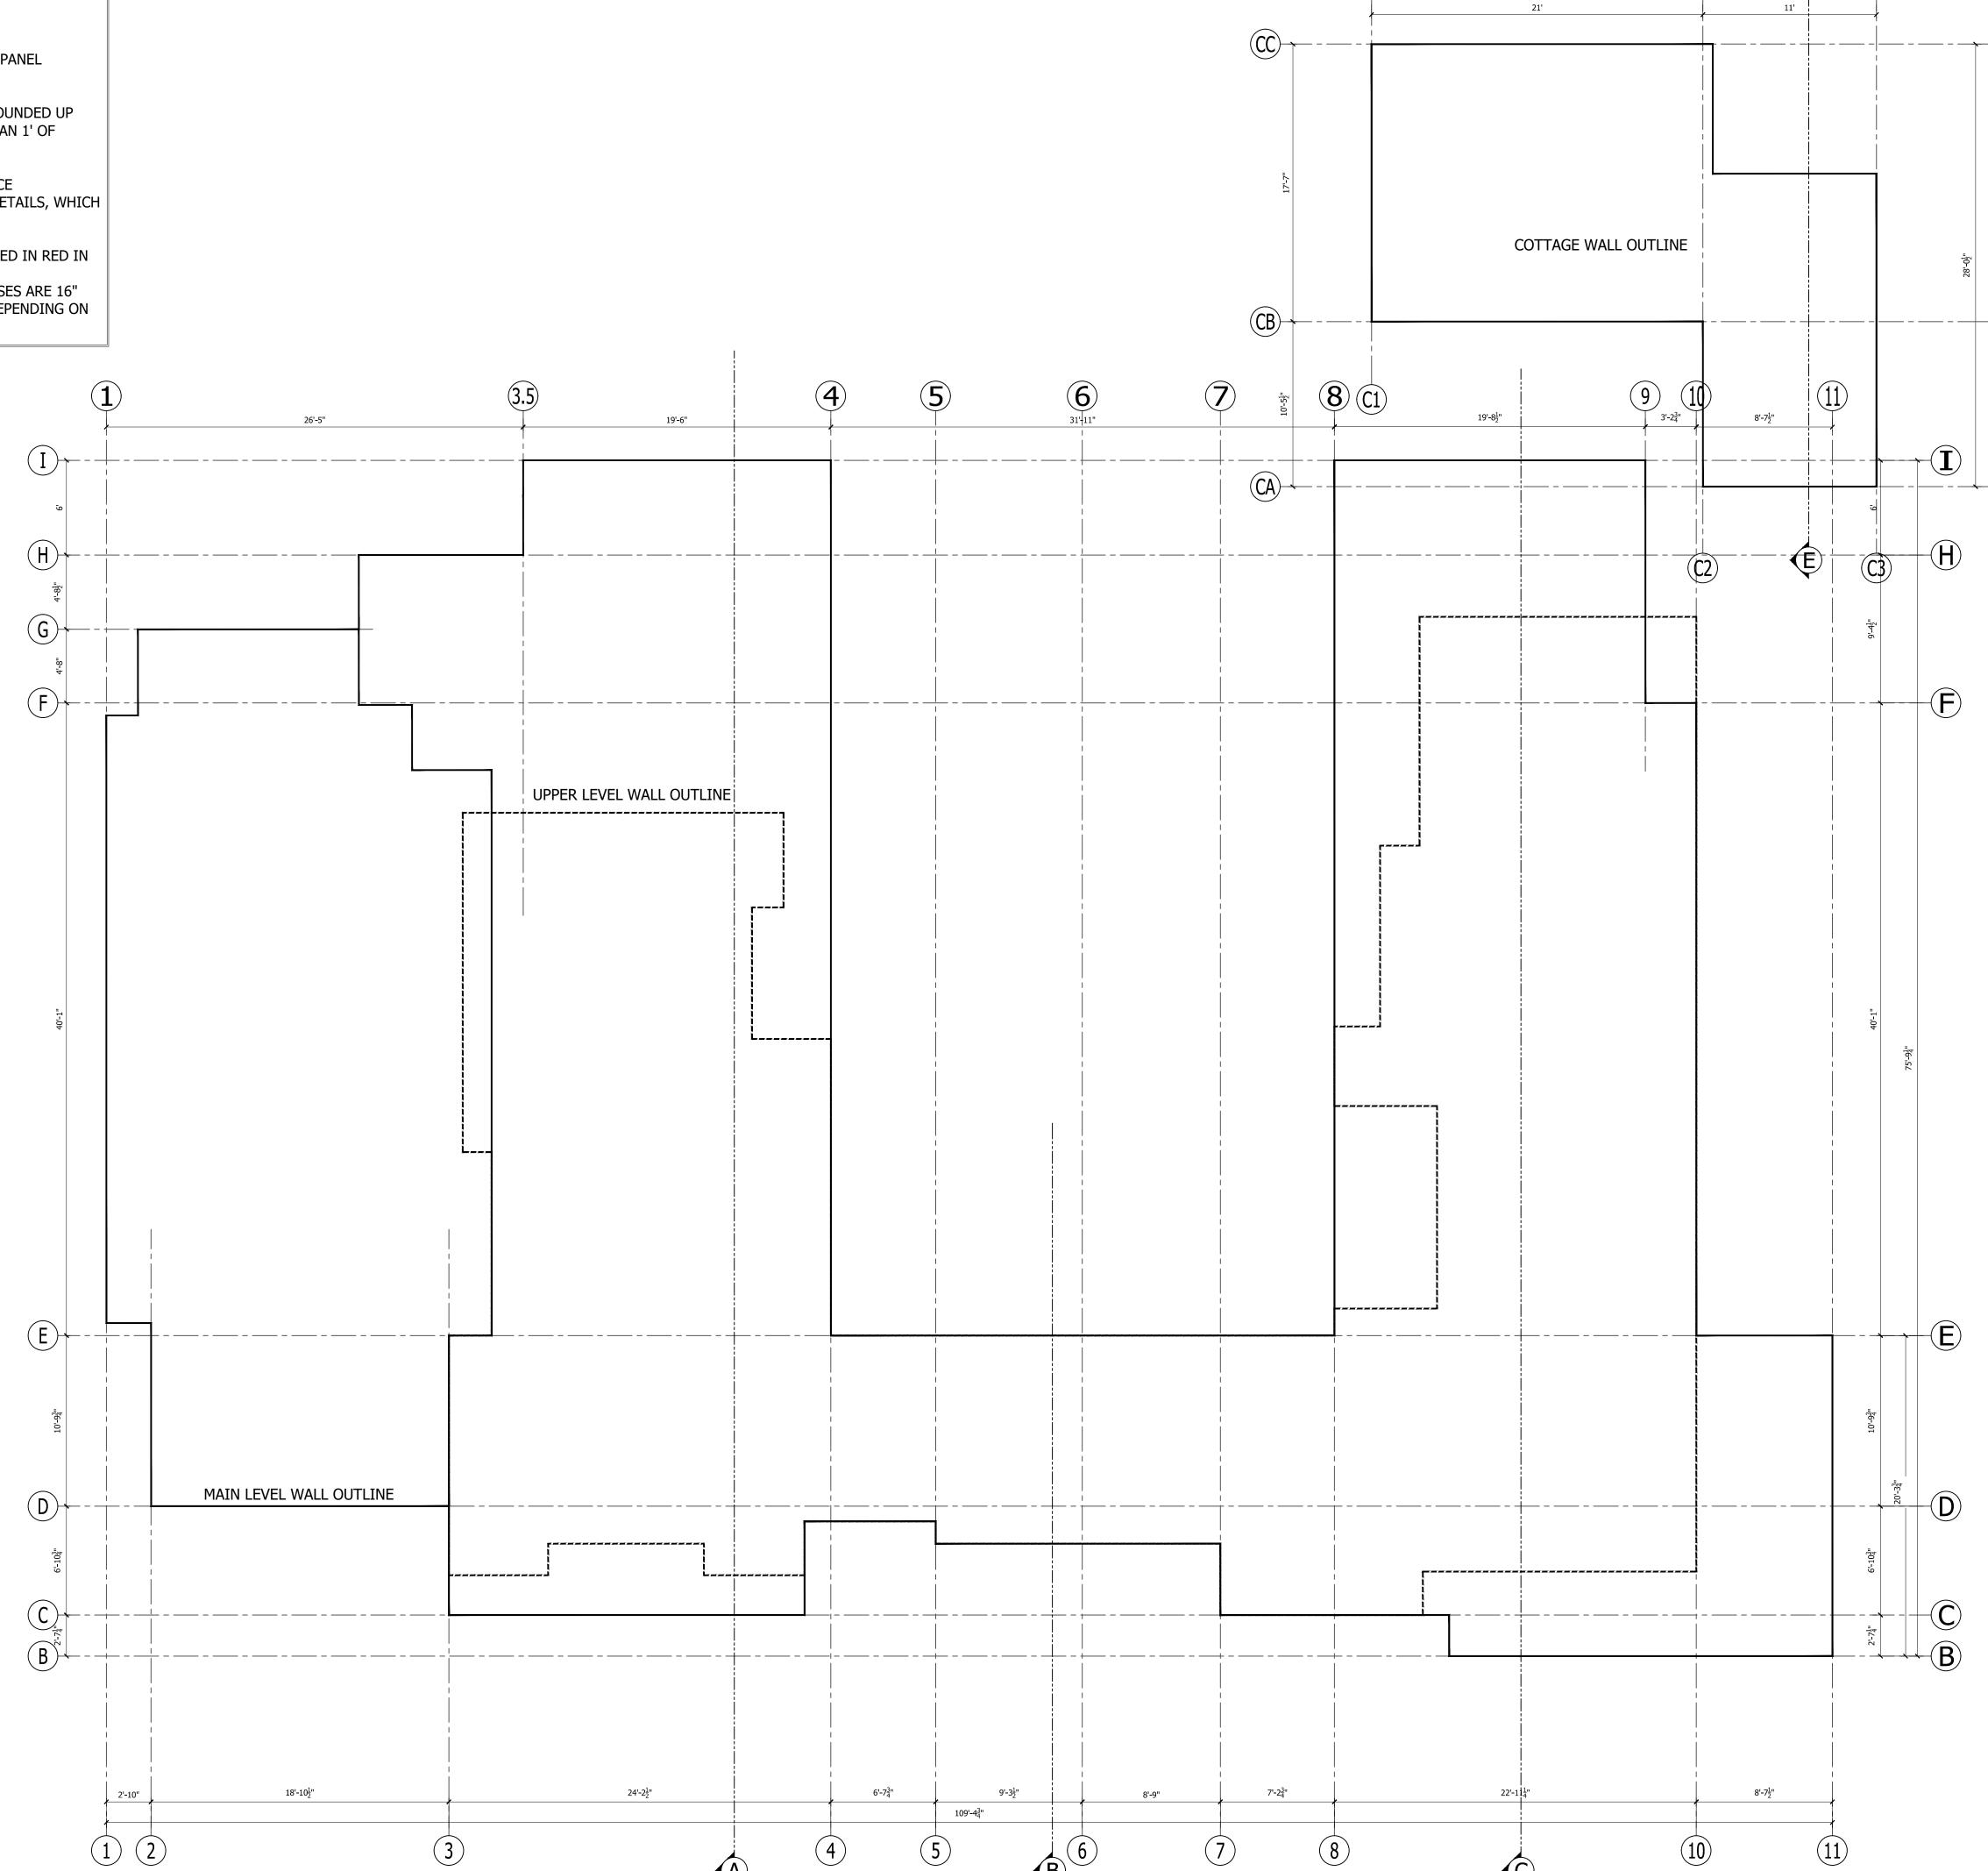

PREMIER STRUCTURAL INSULATED PANELS

18504 Canyon Rd. E. Puyallup, Wa 98375 800-275-7086

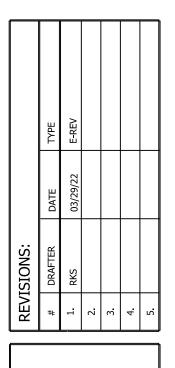

OVERALL PLAN


AS A SUPPLIER OF MATERIALS, PREMIER BUILDING SYSTEMS DOES NOT ASSUME RESPONSIBILITY FOR ERRORS IN DESIGN, ENGINEERING, OR DIMENSIONS. OWNER/AGENT (ARCHITECT, CONTRACTOR, AND/OR INSTALLER) SHALL VERIFY ALL DIMENSIONS AND SIZES AND BY SIGNING THESE PLANS, THE OWNER TAKES FULL RESPONSIBILITY FOR THEIR ACCURACY.

Wang Chen Residence 20210505-0004 Bellevue, WA

AWN: R.STOWERS
ECKED:
ITE: 01/28/2022
ALE: VARIES
HEET
D.

OVERALL PLAN (STRUCTURAL GRID)
6 1/2" PANELS
3/16" = 1'-0"

- 1. SIP WALLS ARE ALIGNED TO STRUCTURAL GRID.
- 2. ALL ENGINEERING PROVIDED BY OTHERS.
- 3. ROUGH OR SMOOTH OSB DOES NOT DENOTE TOP OR BOTTOM OF SIP. REFER TO PANEL
- LAYOUTS FOR PANEL ORIENTATION.
- 4. ALL IN-PLANE, PANEL-TO-PANEL JOINTS PBS-005 U.N.O
- 5. INSULATED HEADERS (IHDR-2 PLY OR IHDR-1 PLY) ARE CUT TO 1' INCREMENTS ROUNDED UP FROM THE REQUIRED ROUGH OPENING. (IF YOU'RE ABOUT TO CUT OFF MORE THAN 1' OF INSULATED HEADER THEN YOU'RE CUTTING THE WRONG ONE).
- 6. SIP TAPE PROVIDED FOR WALL CONNECTIONS ONLY.
- 7. STANDARD DETAILS PROVIDED FOR TYPICAL INSTALLATION METHODS. REFERENCE ARCHITECTURAL AND STRUCTURAL DRAWINGS FOR JOB SPECIFIC CONNECTION DETAILS, WHICH TAKE PRECEDENT OVER PBS TYPICAL DETAILS.
- 8. BEAM POCKETS TO BE FIELD CUT FOR PROPER ELEVATION AND SIZE.
- 9. FACTORY INSTALLED LUMBER (IF REQUESTED BY CUSTOMER) WILL BE HIGHLIGHTED IN RED IN THE SIP PANEL LAYOUTS.
- 10. STANDARD WALL ELECTRICAL CHASES INCLUDED BY DEFAULT. HORIZONTAL CHASES ARE 16" AND 45" ABOVE BOTTOM OF PANEL AND VERTICALLY APPROXIMATELY 4'-0" O.C DEPENDING ON PANEL WIDTHS.

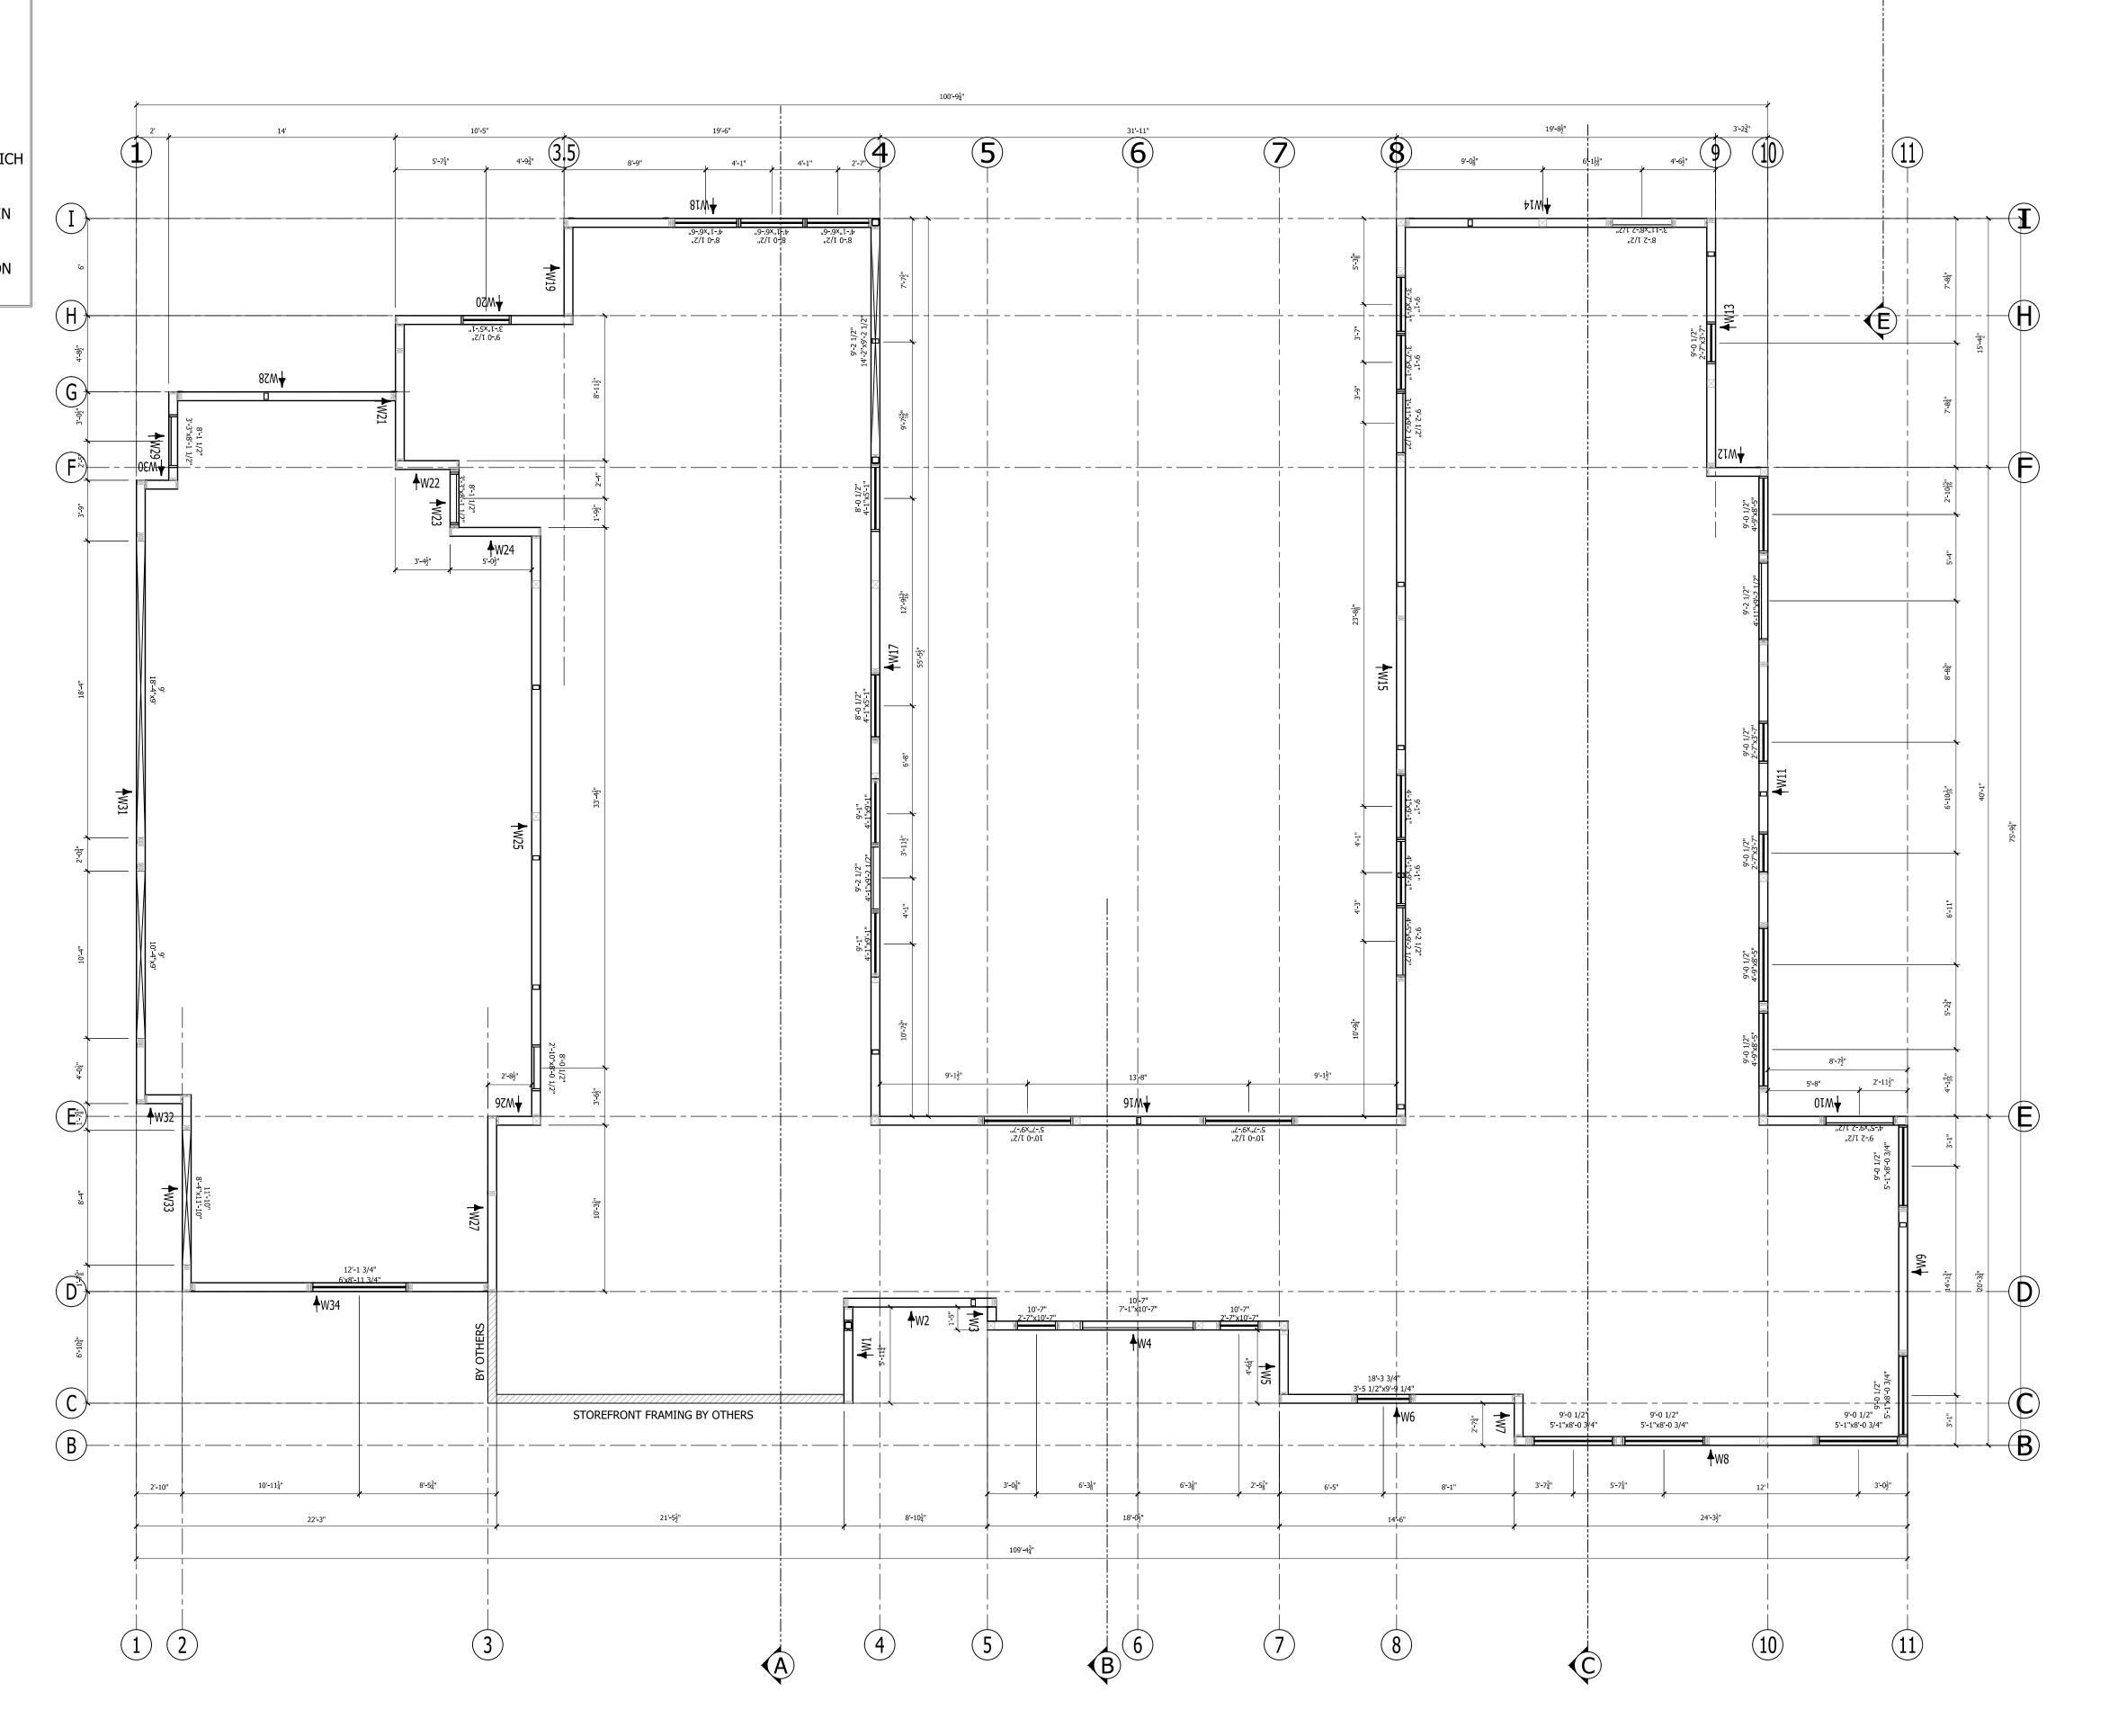

PREMIER PANELS

18504 Canyon Rd. E. Puyallup, Wa 98375 800-275-7086

REV]	REVISIONS:		
#	DRAFTER	DATE	ТҮРЕ
1.	RKS	03/29/22	E-REV
2.			
3.			
4.			
5.			

MAIN LEVEL PANEL WALL PLAN


AS A SUPPLIER OF MATERIALS, PREMIER BUILDING SYSTEMS DOES NOT ASSUME RESPONSIBILITY FOR ERRORS IN DESIGN, ENGINEERING, OR DIMENSIONS. OWNER/AGENT (ARCHITECT, CONTRACTOR, AND/OR INSTALLER) SHALL VERIFY ALL DIMENSIONS AND SIZES AND BY SIGNING THESE PLANS, THE OWNER TAKES FULL RESPONSIBILITY FOR THEIR ACCURACY.

SIGNATURE DATE

Wang Chen Residence 20210505-0004 Bellevue, WA


DRAWN: R.STOWERS
CHECKED:
DATE: 01/28/2022
SCALE: VARIES
SHEET NO. 0F 18

- 1. SIP WALLS ARE ALIGNED TO STRUCTURAL GRID.
- 2. ALL ENGINEERING PROVIDED BY OTHERS.
- 3. ROUGH OR SMOOTH OSB DOES NOT DENOTE TOP OR BOTTOM OF SIP. REFER TO PANEL
- LAYOUTS FOR PANEL ORIENTATION.
- 4. ALL IN-PLANE, PANEL-TO-PANEL JOINTS PBS-005 U.N.O
- 5. INSULATED HEADERS (IHDR-2 PLY OR IHDR-1 PLY) ARE CUT TO 1' INCREMENTS ROUNDED UP FROM THE REQUIRED ROUGH OPENING. (IF YOU'RE ABOUT TO CUT OFF MORE THAN 1' OF INSULATED HEADER THEN YOU'RE CUTTING THE WRONG ONE).
- 6. SIP TAPE PROVIDED FOR WALL CONNECTIONS ONLY.
- 7. STANDARD DETAILS PROVIDED FOR TYPICAL INSTALLATION METHODS. REFERENCE ARCHITECTURAL AND STRUCTURAL DRAWINGS FOR JOB SPECIFIC CONNECTION DETAILS, WHICH TAKE PRECEDENT OVER PBS TYPICAL DETAILS.
- 8. BEAM POCKETS TO BE FIELD CUT FOR PROPER ELEVATION AND SIZE.
- 9. FACTORY INSTALLED LUMBER (IF REQUESTED BY CUSTOMER) WILL BE HIGHLIGHTED IN RED IN THE SIP PANEL LAYOUTS.
- 10. STANDARD WALL ELECTRICAL CHASES INCLUDED BY DEFAULT. HORIZONTAL CHASES ARE 16" AND 45" ABOVE BOTTOM OF PANEL AND VERTICALLY APPROXIMATELY 4'-0" O.C DEPENDING ON PANEL WIDTHS.

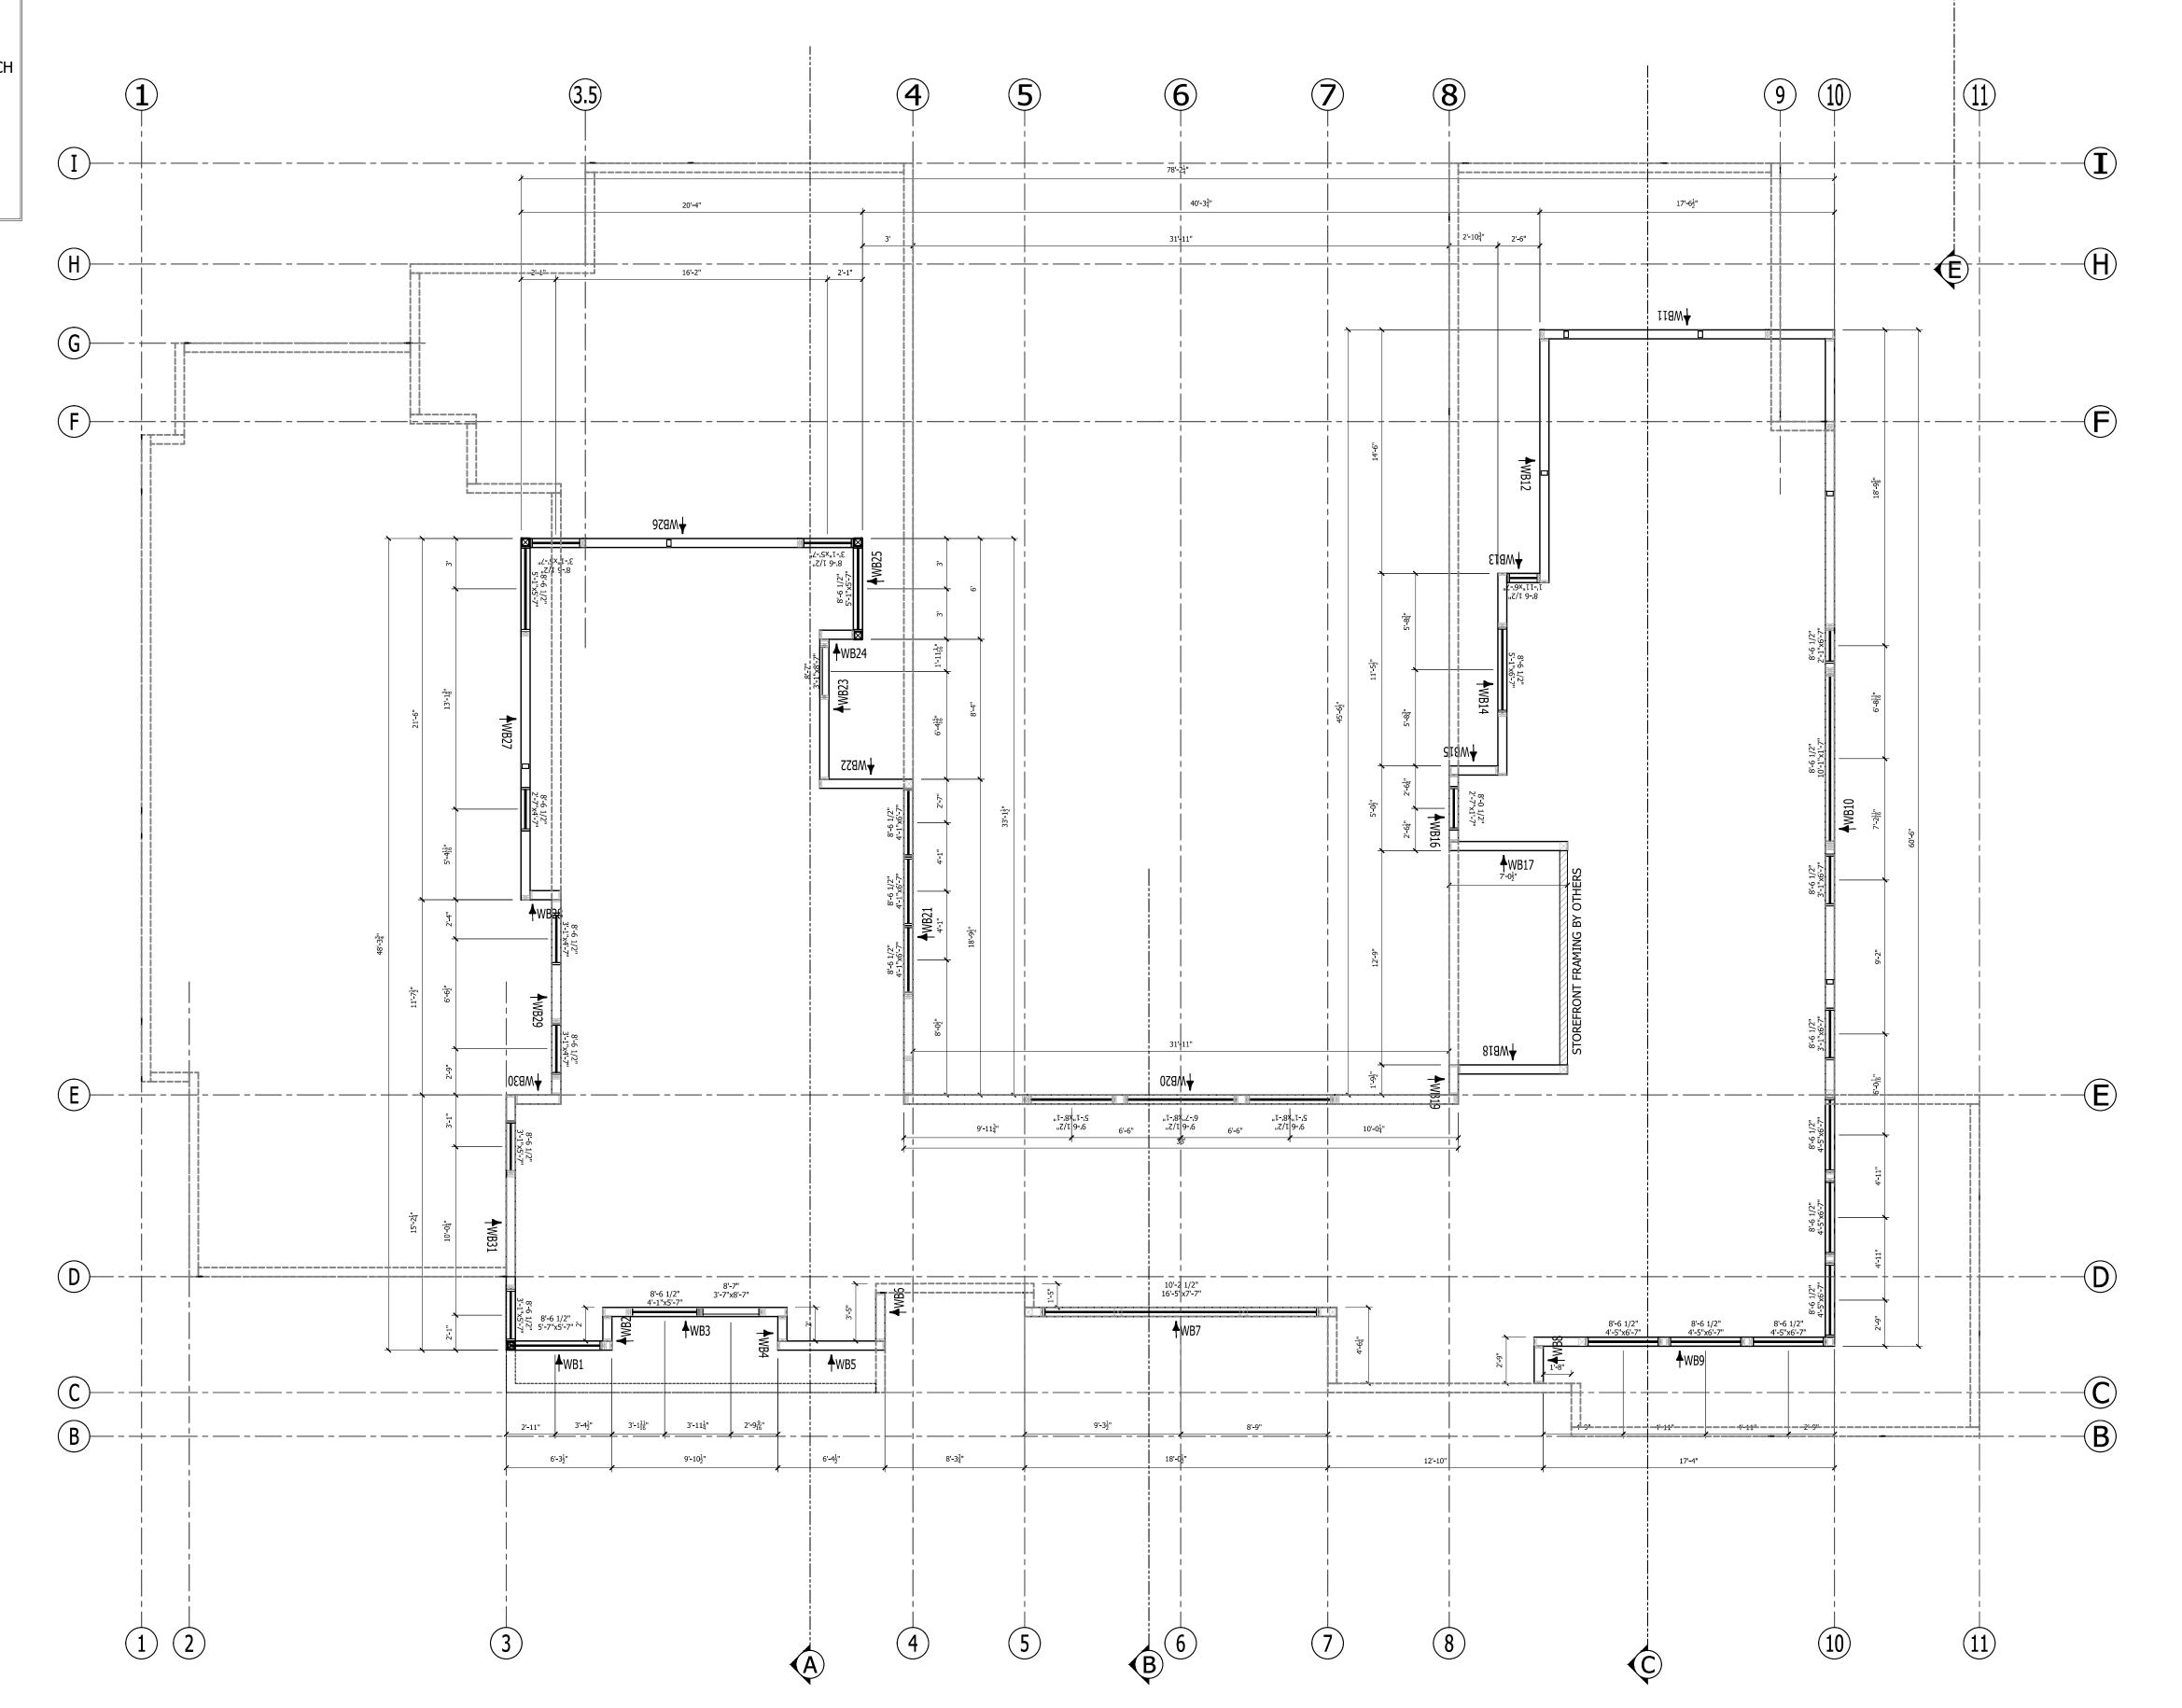



18504 Canyon Rd. E. Puyallup, Wa 98375 800-275-7086

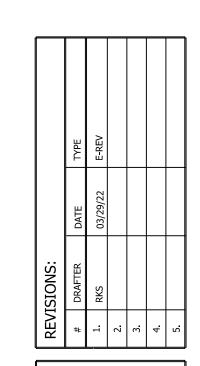

UPPER LEVEL PANEL WALL PLAN

AS A SUPPLIER OF MATERIALS, PREMIER BUILDING SYSTEMS DOES NOT ASSUME RESPONSIBILITY FOR ERRORS IN DESIGN, ENGINEERING, OR DIMENSIONS. OWNER/AGENT (ARCHITECT, CONTRACTOR, AND/OR INSTALLER) SHALL VERIFY ALL DIMENSIONS AND SIZES AND BY SIGNING THESE PLANS, THE OWNER TAKES FULL RESPONSIBILITY FOR THEIR ACCURACY.

Wang Chen Residence 20210505-0004 Bellevue, WA


DRAWN: R.STOWERS

CHECKED: 01/28/2022

SCALE: VARIES

SHEET NO. 1 9


- 1. SIP WALLS ARE ALIGNED TO STRUCTURAL GRID.
- 2. ALL ENGINEERING PROVIDED BY OTHERS.
- 3. ROUGH OR SMOOTH OSB DOES NOT DENOTE TOP OR BOTTOM OF SIP. REFER TO PANEL LAYOUTS FOR PANEL ORIENTATION.
- 4. ALL IN-PLANE, PANEL-TO-PANEL JOINTS PBS-005 U.N.O
- 5. INSULATED HEADERS (IHDR-2 PLY OR IHDR-1 PLY) ARE CUT TO 1' INCREMENTS ROUNDED UP FROM THE REQUIRED ROUGH OPENING. (IF YOU'RE ABOUT TO CUT OFF MORE THAN 1' OF INSULATED HEADER THEN YOU'RE CUTTING THE WRONG ONE).
- 6. SIP TAPE PROVIDED FOR WALL CONNECTIONS ONLY.
- 7. STANDARD DETAILS PROVIDED FOR TYPICAL INSTALLATION METHODS. REFERENCE ARCHITECTURAL AND STRUCTURAL DRAWINGS FOR JOB SPECIFIC CONNECTION DETAILS, WHICH TAKE PRECEDENT OVER PBS TYPICAL DETAILS.
- 8. BEAM POCKETS TO BE FIELD CUT FOR PROPER ELEVATION AND SIZE.
- 9. FACTORY INSTALLED LUMBER (IF REQUESTED BY CUSTOMER) WILL BE HIGHLIGHTED IN RED IN THE SIP PANEL LAYOUTS.
- 10. STANDARD WALL ELECTRICAL CHASES INCLUDED BY DEFAULT. HORIZONTAL CHASES ARE 16" AND 45" ABOVE BOTTOM OF PANEL AND VERTICALLY APPROXIMATELY 4'-0" O.C DEPENDING ON PANEL WIDTHS.

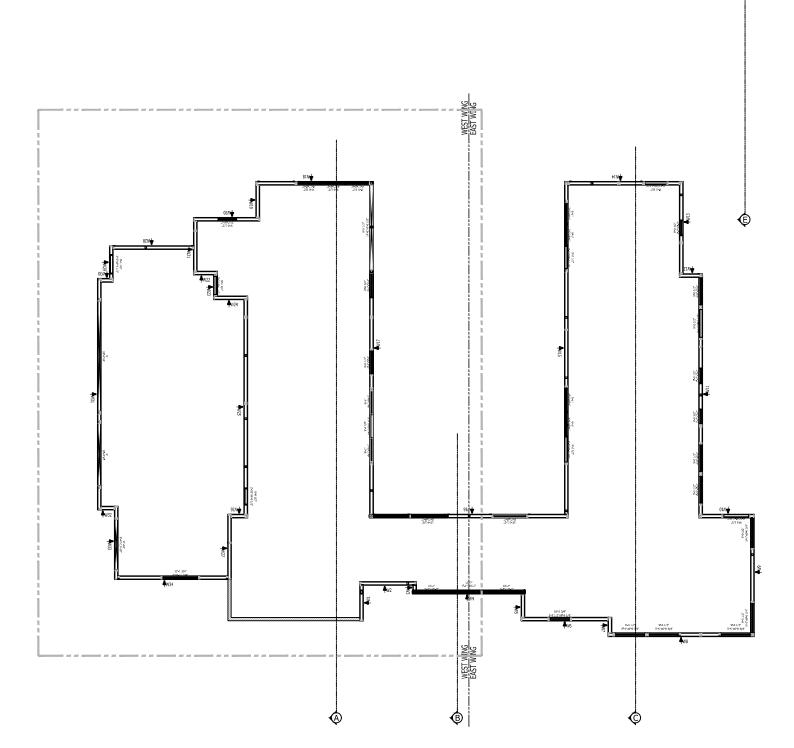

KEY PLAN

WEST WING MAIN LEVEL PANEL WALL PLAN
6 1/2" PANELS

1/4" = 1'-0"

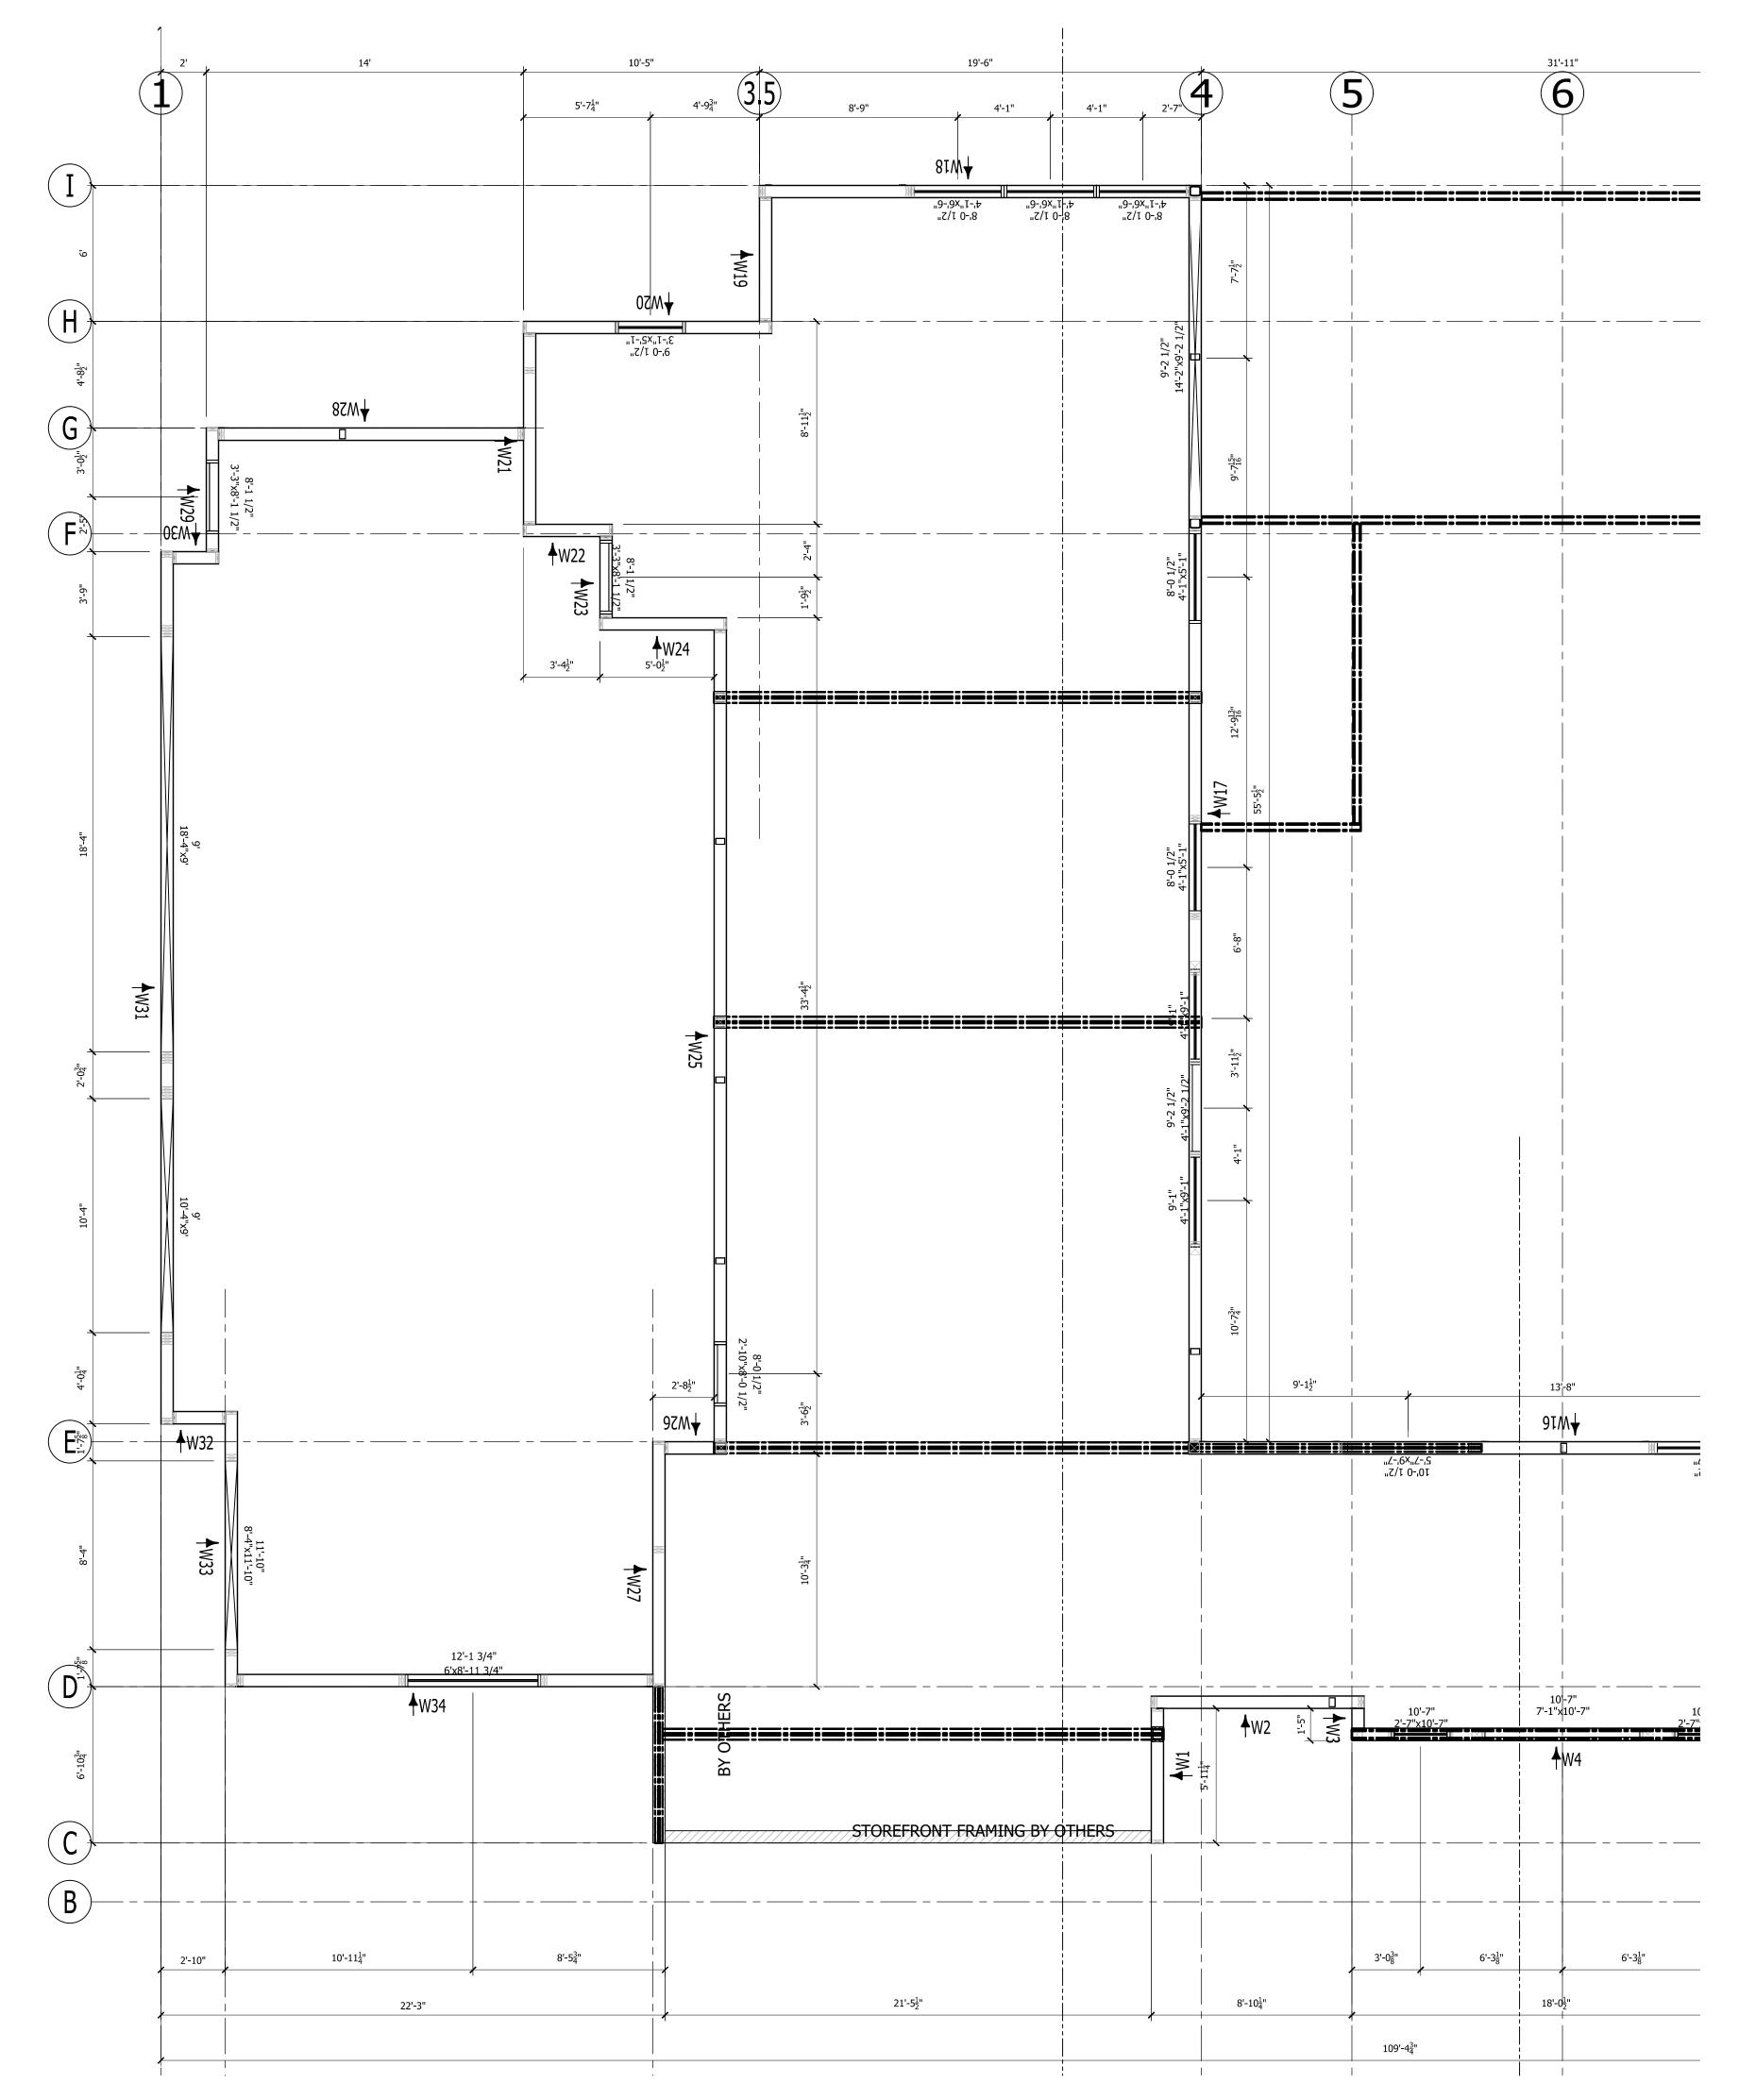



18504 Canyon Rd. E. Puyallup, Wa 98375 800-275-7086

	TYPE	E-REV				
	DATE	03/29/22				
REVISIONS:	DRAFTER	RKS				
REVI:	#	1.	2.	3	4.	5.

WEST WING - MAIN LEV PANEL WALL PLAN

AS A SUPPLIER OF MATERIALS, PREMIER BUILDING SYSTEMS DOES NOT ASSUME RESPONSIBILITY FOR ERRORS IN DESIGN, ENGINEERING, OR DIMENSIONS. OWNER/AGENT (ARCHITECT, CONTRACTOR, AND/OR INSTALLER) SHALL VERIEY ALL DIMENSIONS AND BY SIGNING THESE PLANS, THE OWNER TAKES FULL RESPONSIBILITY FOR THEIR ACCURACY.

SIGNATURE


DATE

Wang Chen Residence
20210505-0004

DRAWN:	R.STOWERS
CHECKED:	
DATE:	01/28/2022
SCALE:	VARIES
SHEET NO.	of 18


IOTES:

- 1. SIP WALLS ARE ALIGNED TO STRUCTURAL GRID.
- 2. ALL ENGINEERING PROVIDED BY OTHERS.
- 3. ROUGH OR SMOOTH OSB DOES NOT DENOTE TOP OR BOTTOM OF SIP. REFER TO PANEL LAYOUTS FOR PANEL ORIENTATION.
- 4. ALL IN-PLANE, PANEL-TO-PANEL JOINTS PBS-005 U.N.O
- 5. INSULATED HEADERS (IHDR-2 PLY OR IHDR-1 PLY) ARE CUT TO 1' INCREMENTS ROUNDED UP FROM THE REQUIRED ROUGH OPENING. (IF YOU'RE ABOUT TO CUT OFF MORE THAN 1' OF INSULATED HEADER THEN YOU'RE CUTTING THE WRONG ONE).
- 6. SIP TAPE PROVIDED FOR WALL CONNECTIONS ONLY.
- 7. STANDARD DETAILS PROVIDED FOR TYPICAL INSTALLATION METHODS. REFERENCE ARCHITECTURAL AND STRUCTURAL DRAWINGS FOR JOB SPECIFIC CONNECTION DETAILS, WHICH TAKE PRECEDENT OVER PBS TYPICAL DETAILS.
- 8. BEAM POCKETS TO BE FIELD CUT FOR PROPER ELEVATION AND SIZE.
- 9. FACTORY INSTALLED LUMBER (IF REQUESTED BY CUSTOMER) WILL BE HIGHLIGHTED IN RED IN THE SIP PANEL LAYOUTS.
- 10. STANDARD WALL ELECTRICAL CHASES INCLUDED BY DEFAULT. HORIZONTAL CHASES ARE 16" AND 45" ABOVE BOTTOM OF PANEL AND VERTICALLY APPROXIMATELY 4'-0" O.C DEPENDING ON PANEL WIDTHS.

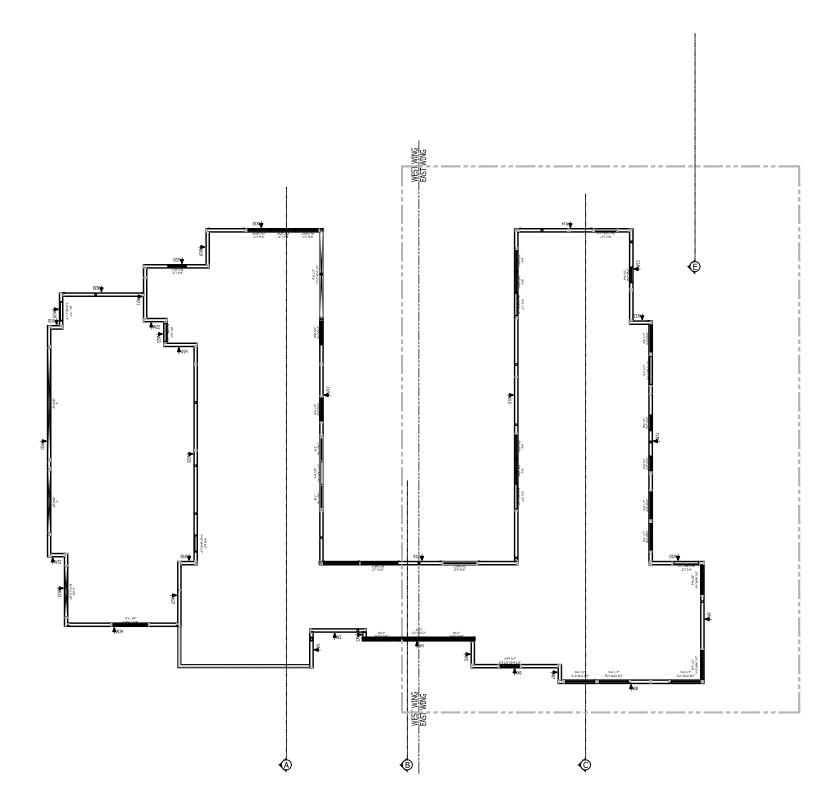


KEY PLAN

EAST WING MAIN LEVEL PANEL WALL PLAN 6 1/2" PANELS 1/4" = 1'-0"

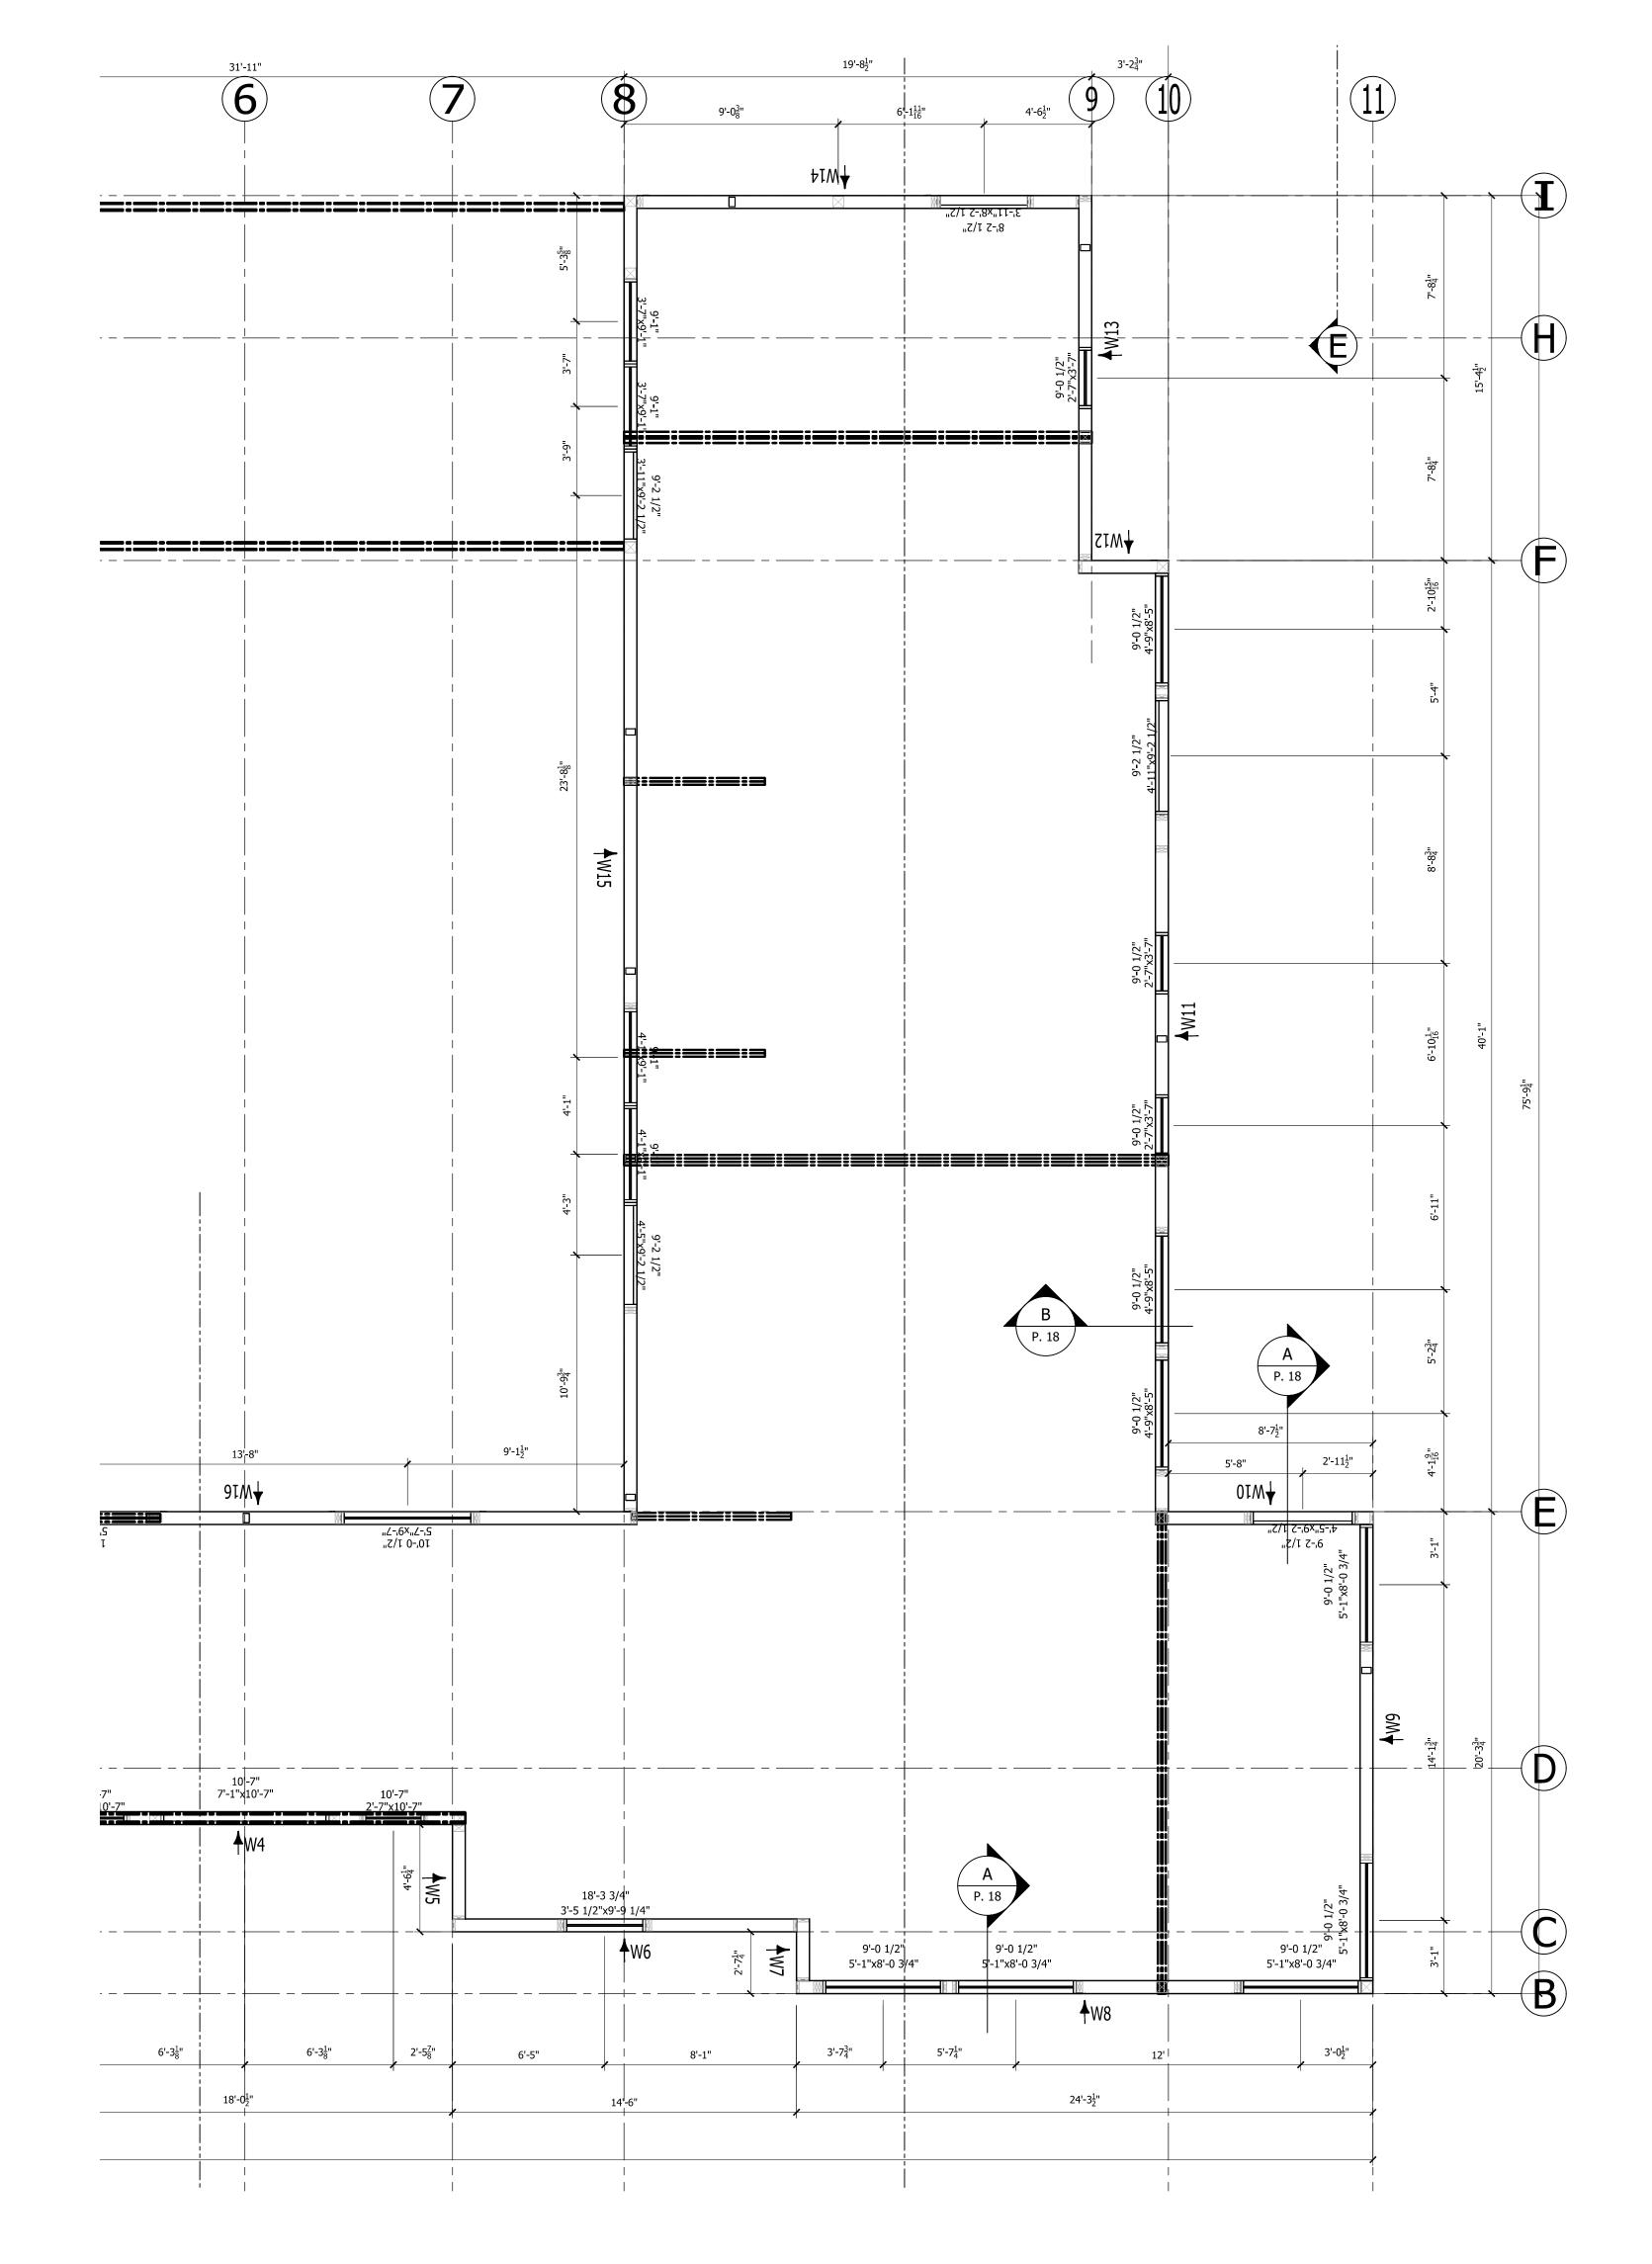




18504 Canyon Rd. E. Puyallup, Wa 98375 800-275-7086

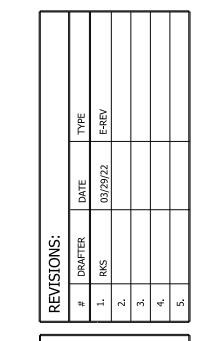


EAST WING - MAIN LEVEL PANEL WALL PLAN

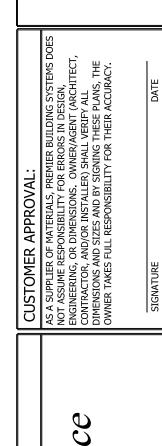

Wang Chen Residence 20210505-0004 Bellevue, WA

DRAWN:	R.STOWERS
CHECKED:	
DATE:	01/28/2022
SCALE:	VARIES
SHEET NO.	OF 18


- 1. SIP WALLS ARE ALIGNED TO STRUCTURAL GRID.
- 2. ALL ENGINEERING PROVIDED BY OTHERS.
- 3. ROUGH OR SMOOTH OSB DOES NOT DENOTE TOP OR BOTTOM OF SIP. REFER TO PANEL
- LAYOUTS FOR PANEL ORIENTATION.
- 4. ALL IN-PLANE, PANEL-TO-PANEL JOINTS PBS-005 U.N.O
- 5. INSULATED HEADERS (IHDR-2 PLY OR IHDR-1 PLY) ARE CUT TO 1' INCREMENTS ROUNDED UP FROM THE REQUIRED ROUGH OPENING. (IF YOU'RE ABOUT TO CUT OFF MORE THAN 1' OF INSULATED HEADER THEN YOU'RE CUTTING THE WRONG ONE).
- 6. SIP TAPE PROVIDED FOR WALL CONNECTIONS ONLY.
- 7. STANDARD DETAILS PROVIDED FOR TYPICAL INSTALLATION METHODS. REFERENCE ARCHITECTURAL AND STRUCTURAL DRAWINGS FOR JOB SPECIFIC CONNECTION DETAILS, WHICH TAKE PRECEDENT OVER PBS TYPICAL DETAILS.
- 8. BEAM POCKETS TO BE FIELD CUT FOR PROPER ELEVATION AND SIZE.
- 9. FACTORY INSTALLED LUMBER (IF REQUESTED BY CUSTOMER) WILL BE HIGHLIGHTED IN RED IN THE SIP PANEL LAYOUTS.
- 10. STANDARD WALL ELECTRICAL CHASES INCLUDED BY DEFAULT. HORIZONTAL CHASES ARE 16" AND 45" ABOVE BOTTOM OF PANEL AND VERTICALLY APPROXIMATELY 4'-0" O.C DEPENDING ON PANEL WIDTHS.

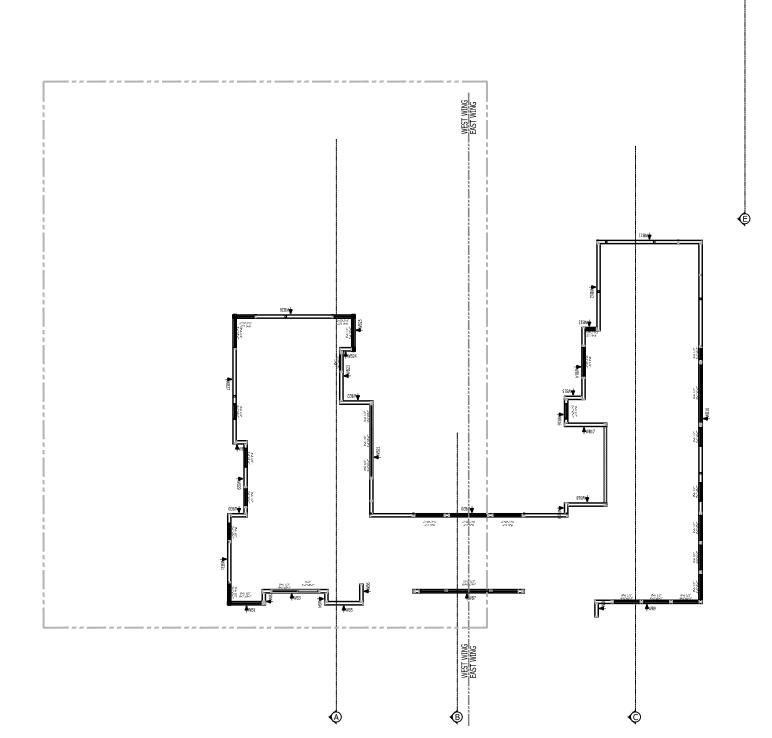

KEY PLAN


WEST WING UPPER LEVEL PANEL WALL PLAN
6 1/2" PANELS

1/4" = 1'-0"

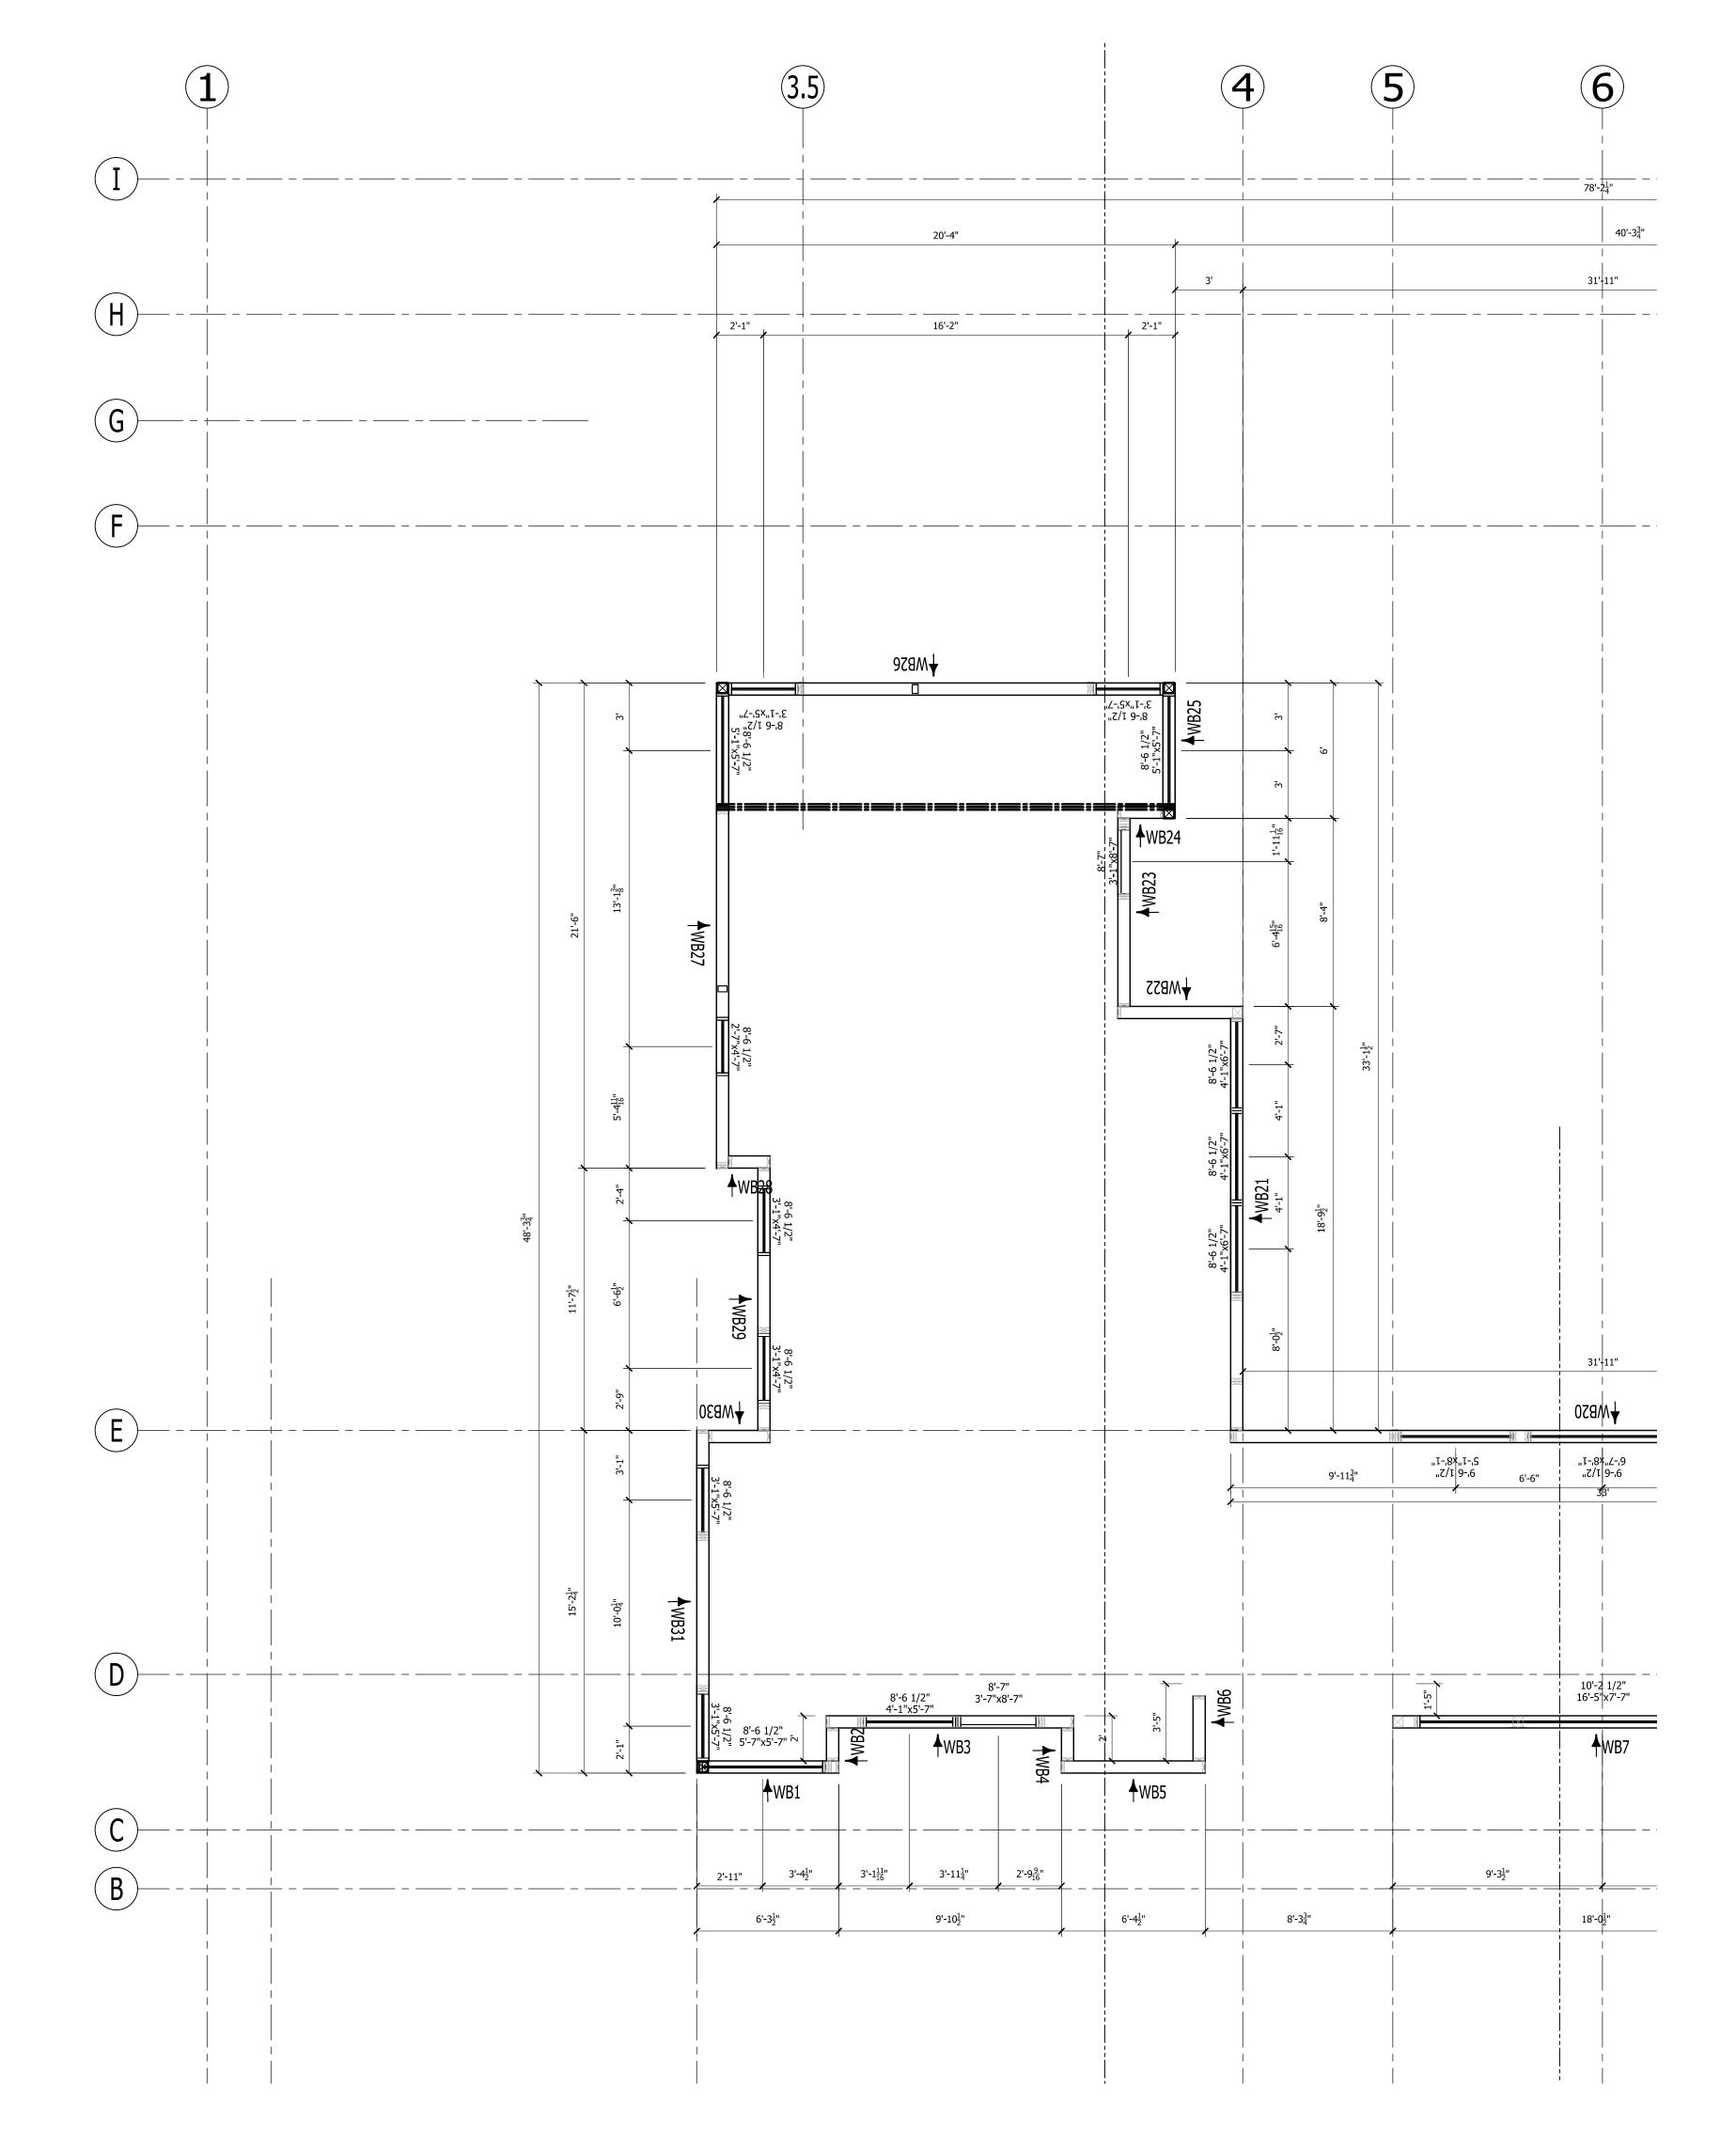




18504 Canyon Rd. E. Puyallup, Wa 98375 800-275-7086

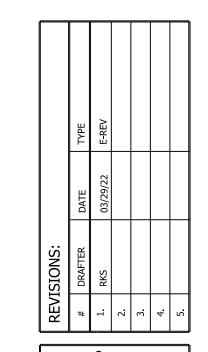


WEST WING - UPPER LEVEL PANEL WALL PLAN

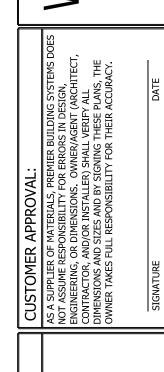


Wang Chen Residence 20210505-0004 Bellevue, WA


RAWN:	R.STOWERS
IECKED:	
ATE:	01/28/2022
CALE:	VARIES
7. 7	OF 18

- 1. SIP WALLS ARE ALIGNED TO STRUCTURAL GRID.
- 2. ALL ENGINEERING PROVIDED BY OTHERS.
- 3. ROUGH OR SMOOTH OSB DOES NOT DENOTE TOP OR BOTTOM OF SIP. REFER TO PANEL LAYOUTS FOR PANEL ORIENTATION.
- 4. ALL IN-PLANE, PANEL-TO-PANEL JOINTS PBS-005 U.N.O
- 5. INSULATED HEADERS (IHDR-2 PLY OR IHDR-1 PLY) ARE CUT TO 1' INCREMENTS ROUNDED UP FROM THE REQUIRED ROUGH OPENING. (IF YOU'RE ABOUT TO CUT OFF MORE THAN 1' OF INSULATED HEADER THEN YOU'RE CUTTING THE WRONG ONE).
- 6. SIP TAPE PROVIDED FOR WALL CONNECTIONS ONLY.
- 7. STANDARD DETAILS PROVIDED FOR TYPICAL INSTALLATION METHODS. REFERENCE ARCHITECTURAL AND STRUCTURAL DRAWINGS FOR JOB SPECIFIC CONNECTION DETAILS, WHICH TAKE PRECEDENT OVER PBS TYPICAL DETAILS.
- 8. BEAM POCKETS TO BE FIELD CUT FOR PROPER ELEVATION AND SIZE.
- 9. FACTORY INSTALLED LUMBER (IF REQUESTED BY CUSTOMER) WILL BE HIGHLIGHTED IN RED IN THE SIP PANEL LAYOUTS.
- 10. STANDARD WALL ELECTRICAL CHASES INCLUDED BY DEFAULT. HORIZONTAL CHASES ARE 16" AND 45" ABOVE BOTTOM OF PANEL AND VERTICALLY APPROXIMATELY 4'-0" O.C DEPENDING ON PANEL WIDTHS.

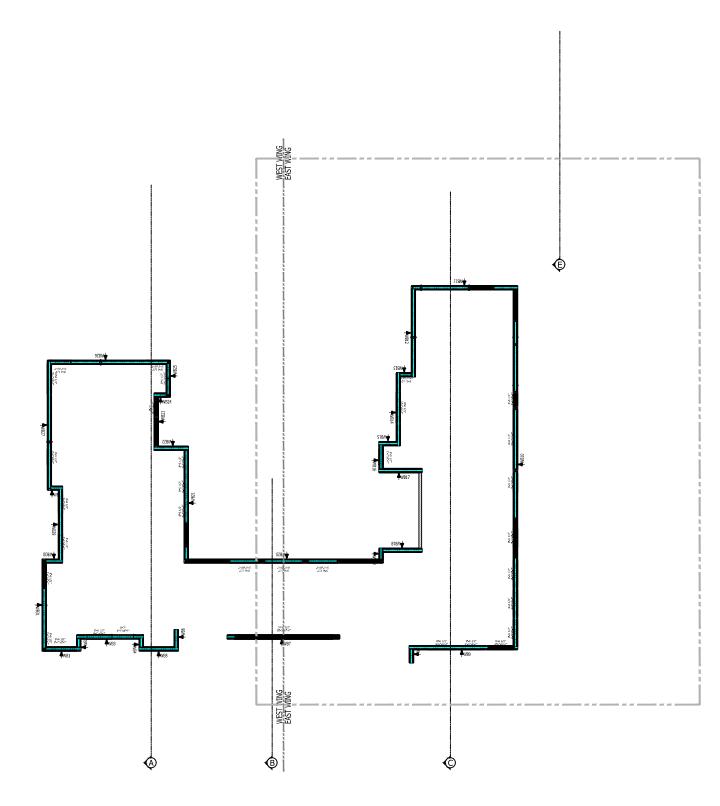

KEY PLAN

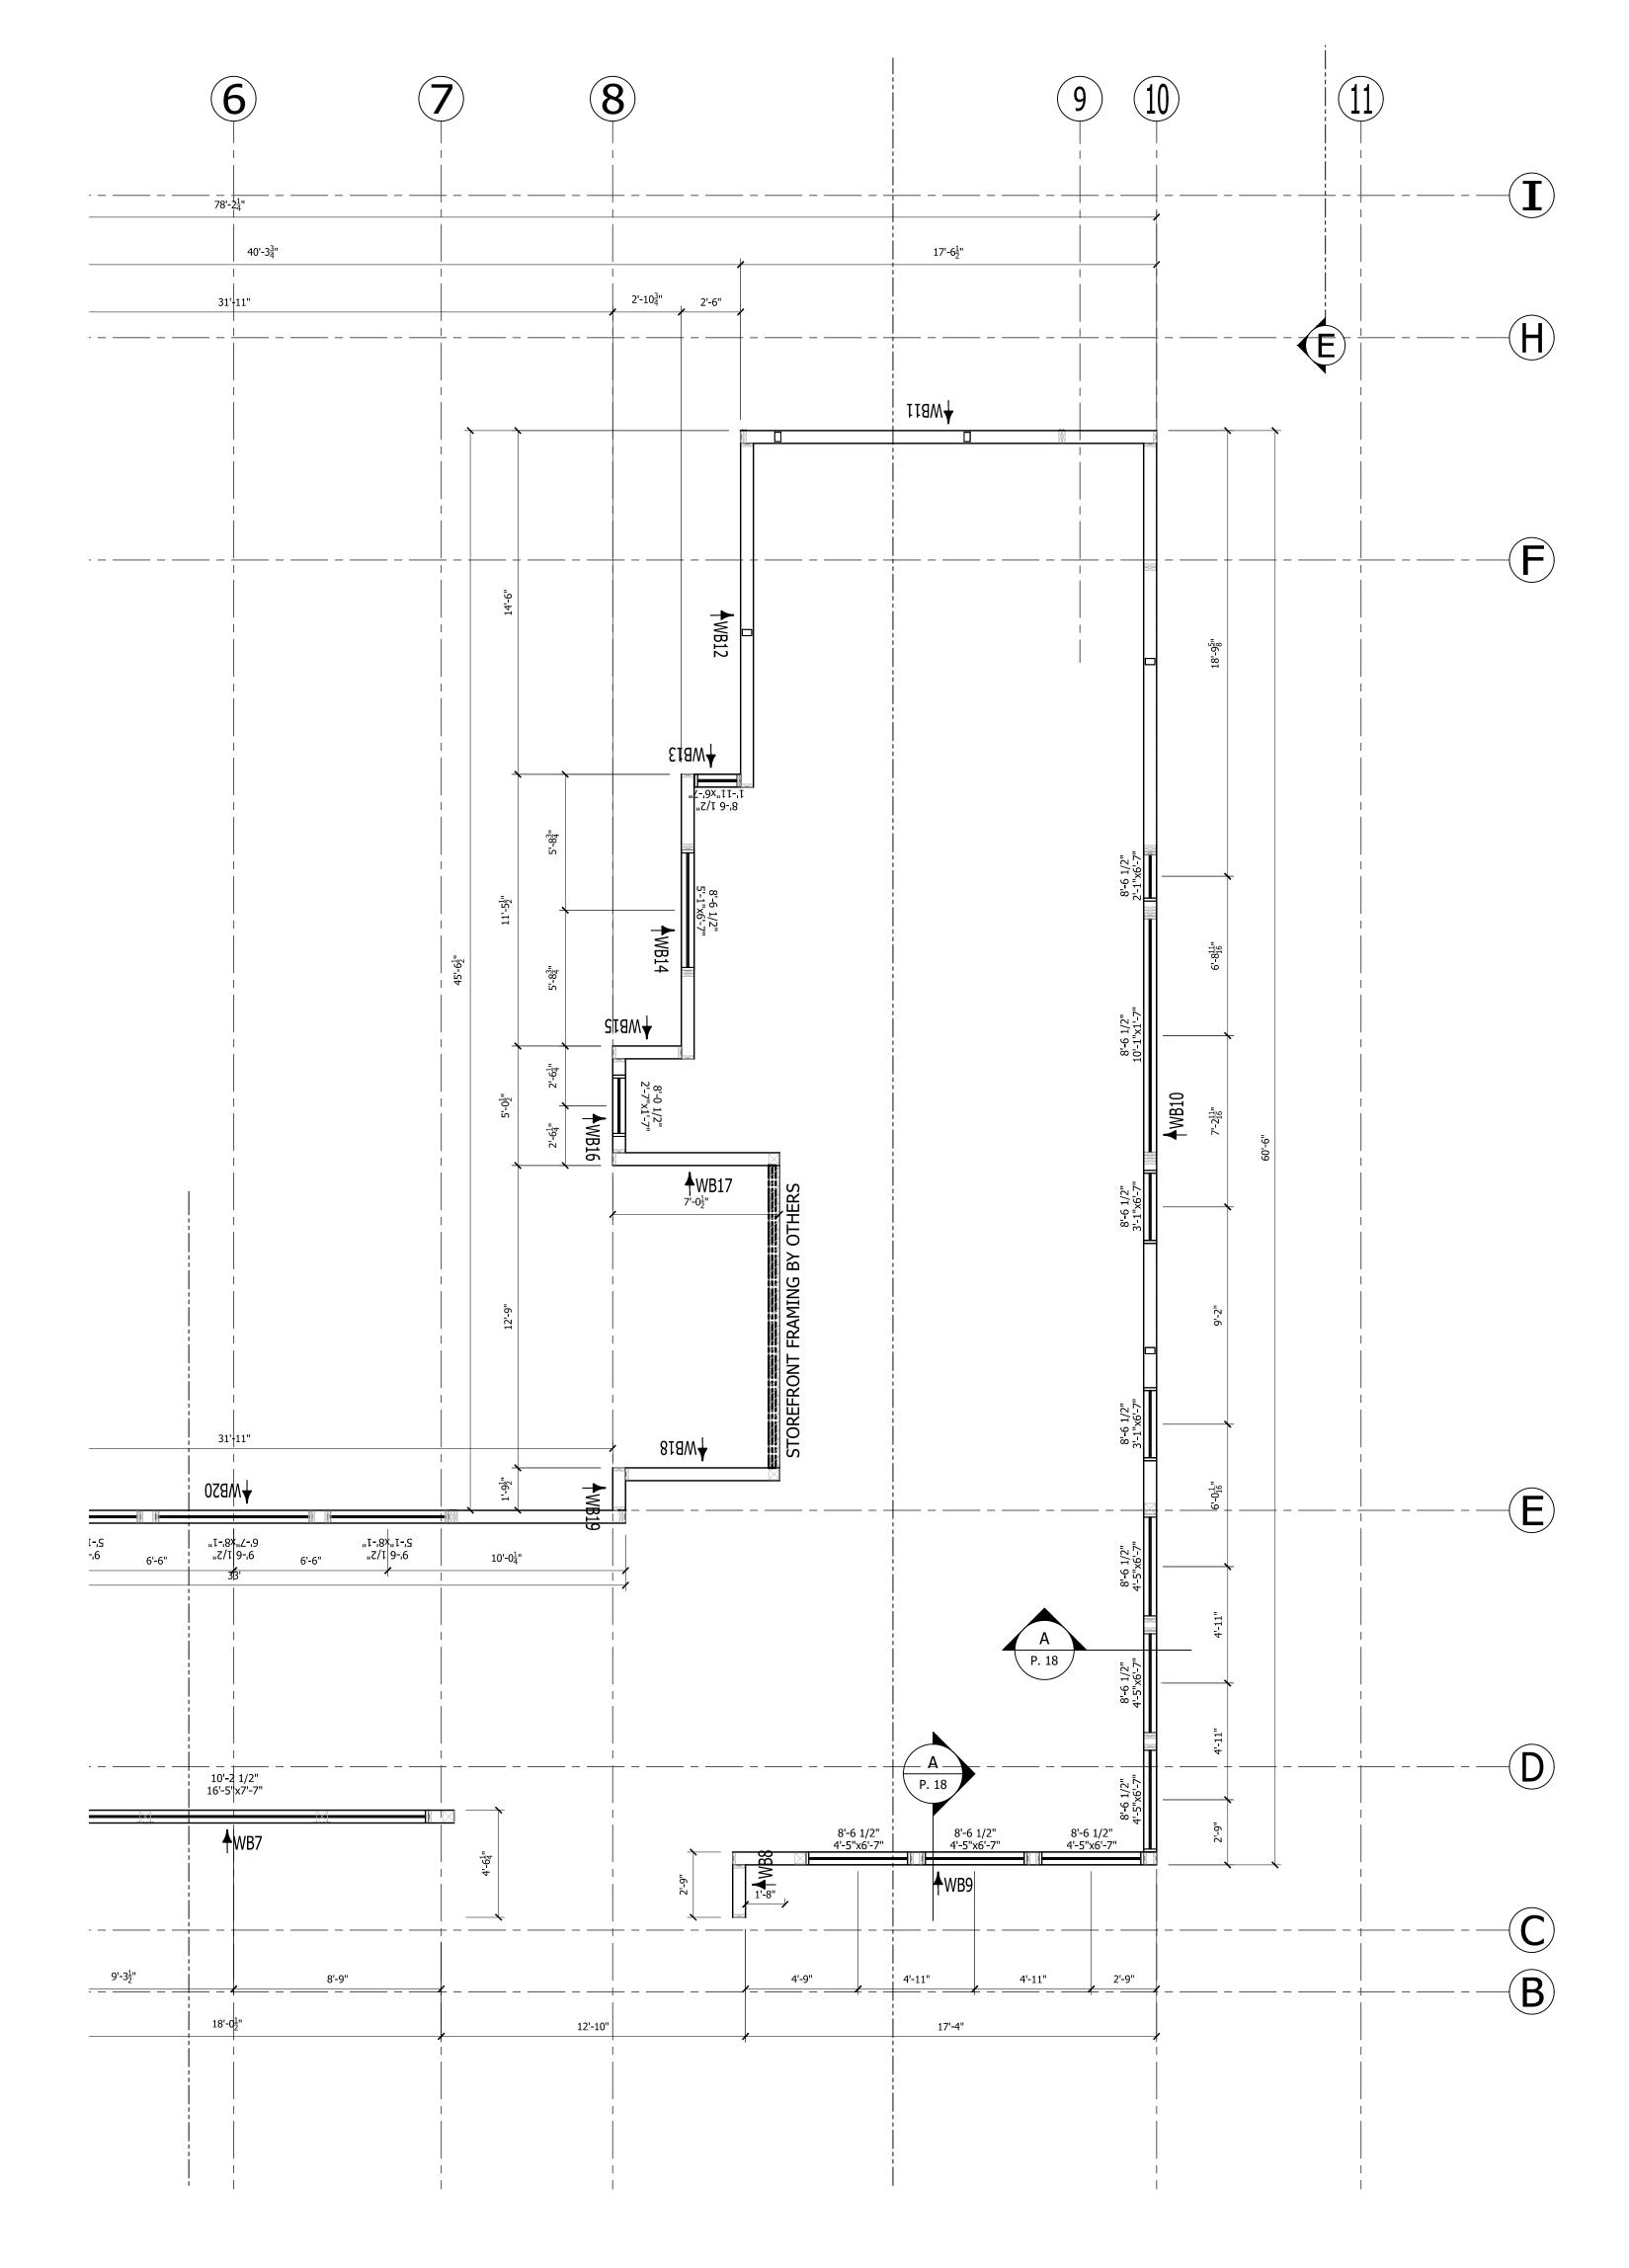

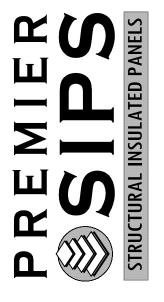

18504 Canyon Rd. E. Puyallup, Wa 98375 800-275-7086

REV]	REVISIONS:		
#	DRAFTER	DATE	ТҮРЕ
1.	RKS	03/29/22	E-REV
2.			
3.			
4			
5.			

EAST WING - UPPER LEVEL PANEL WALL PLAN

CUSTOMER APPROVAL:

AS A SUPPLIER OF MATERIALS, PREMIER BUILDING SYSTEMS DOES
NOT ASSUME RESPONSIBILITY FOR ERRORS IN DESIGN,
ENGINEERING, OR DIMENSIONS. OWNER/AGENT (ARCHITECT,
CONTRACTOR, AND/OR INSTALLER) SHALL VERIFY ALL
DIMENSIONS AND SIZES AND BY SIGNING THESE PLANS, THE
OWNER TAKES FULL RESPONSIBILITY FOR THEIR ACCURACY.

SIGNATURE

Wang Chen Residence 20210505-0004 Bellevue, WA

R.STOWERS


CCKED:


TE: 01/28/2022

LE: VARIES

TET OF 18

EAST WING UPPER LEVEL PANEL WALL PLAN 6 1/2" PANELS 1/4" = 1'-0"

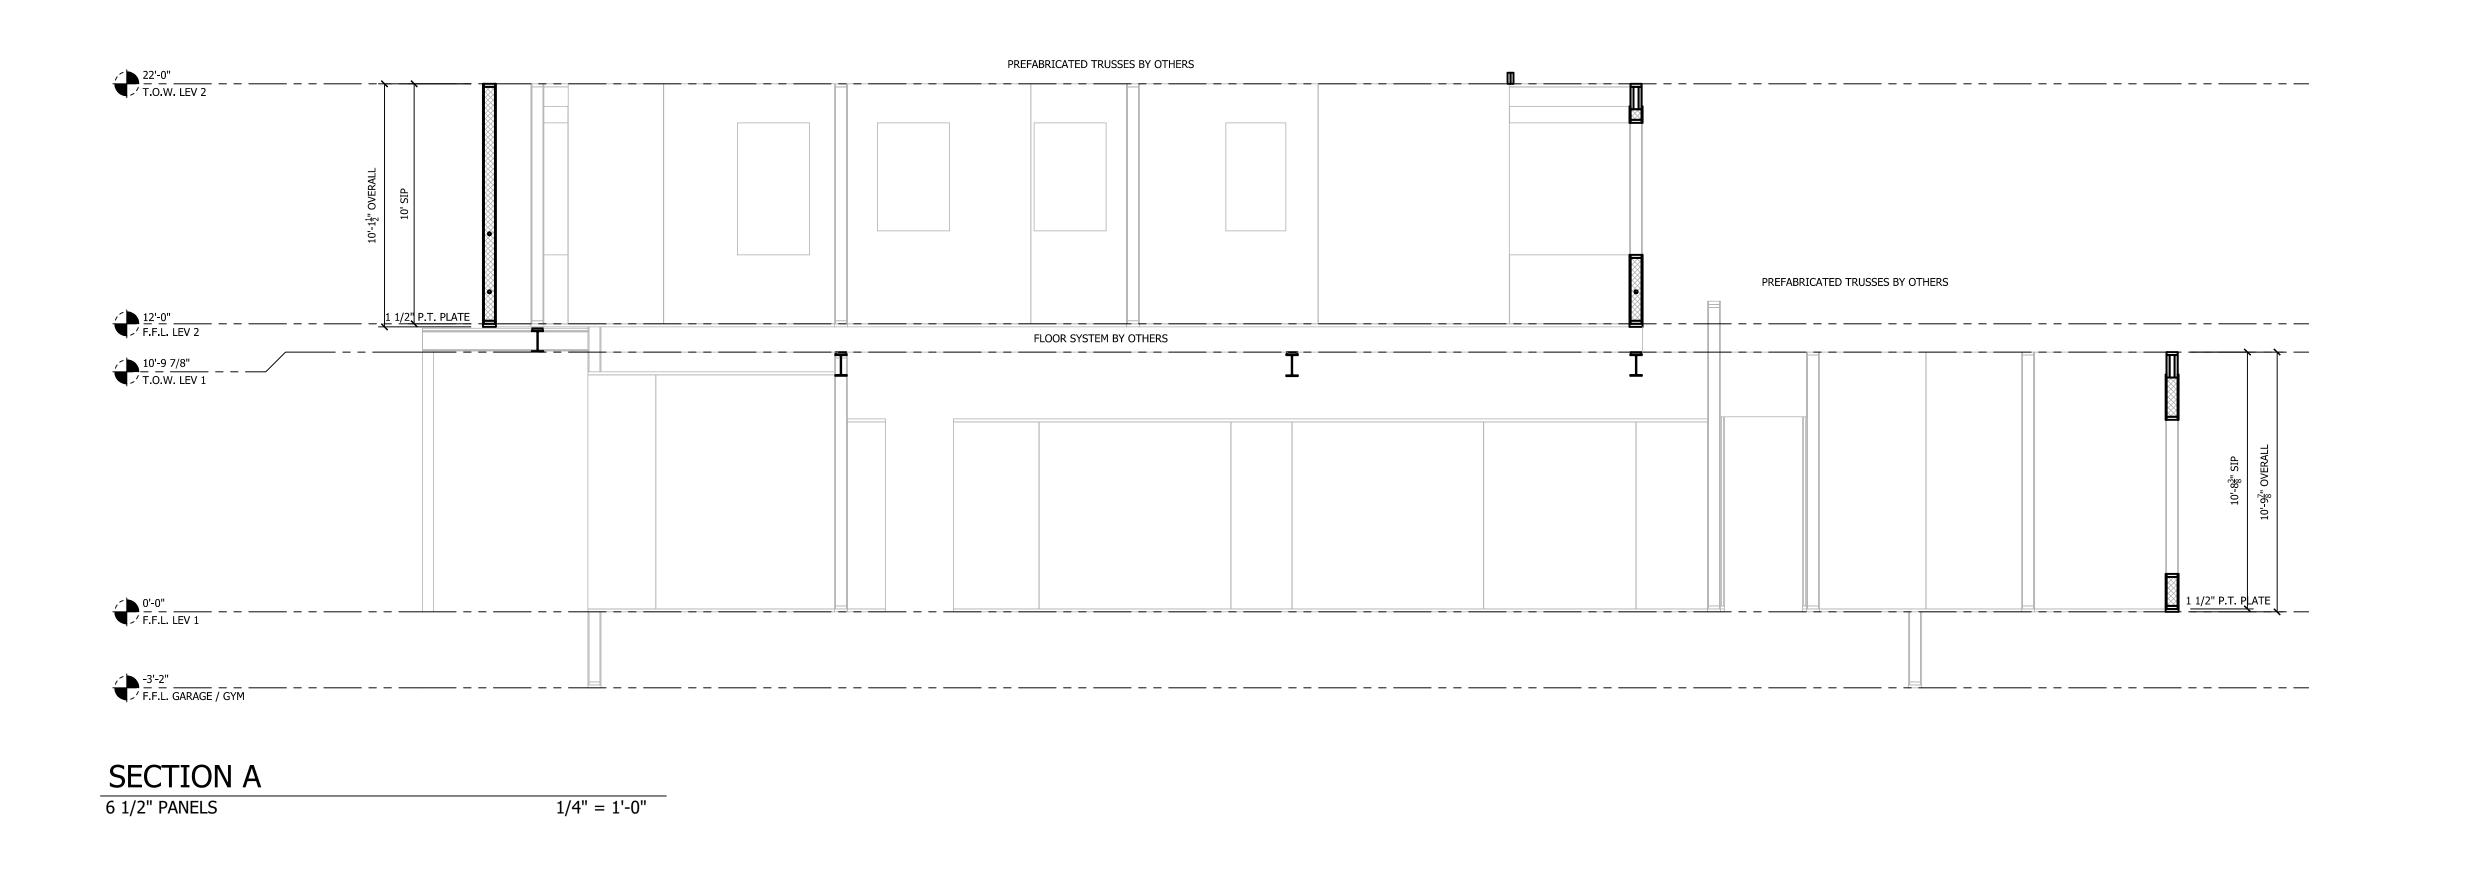

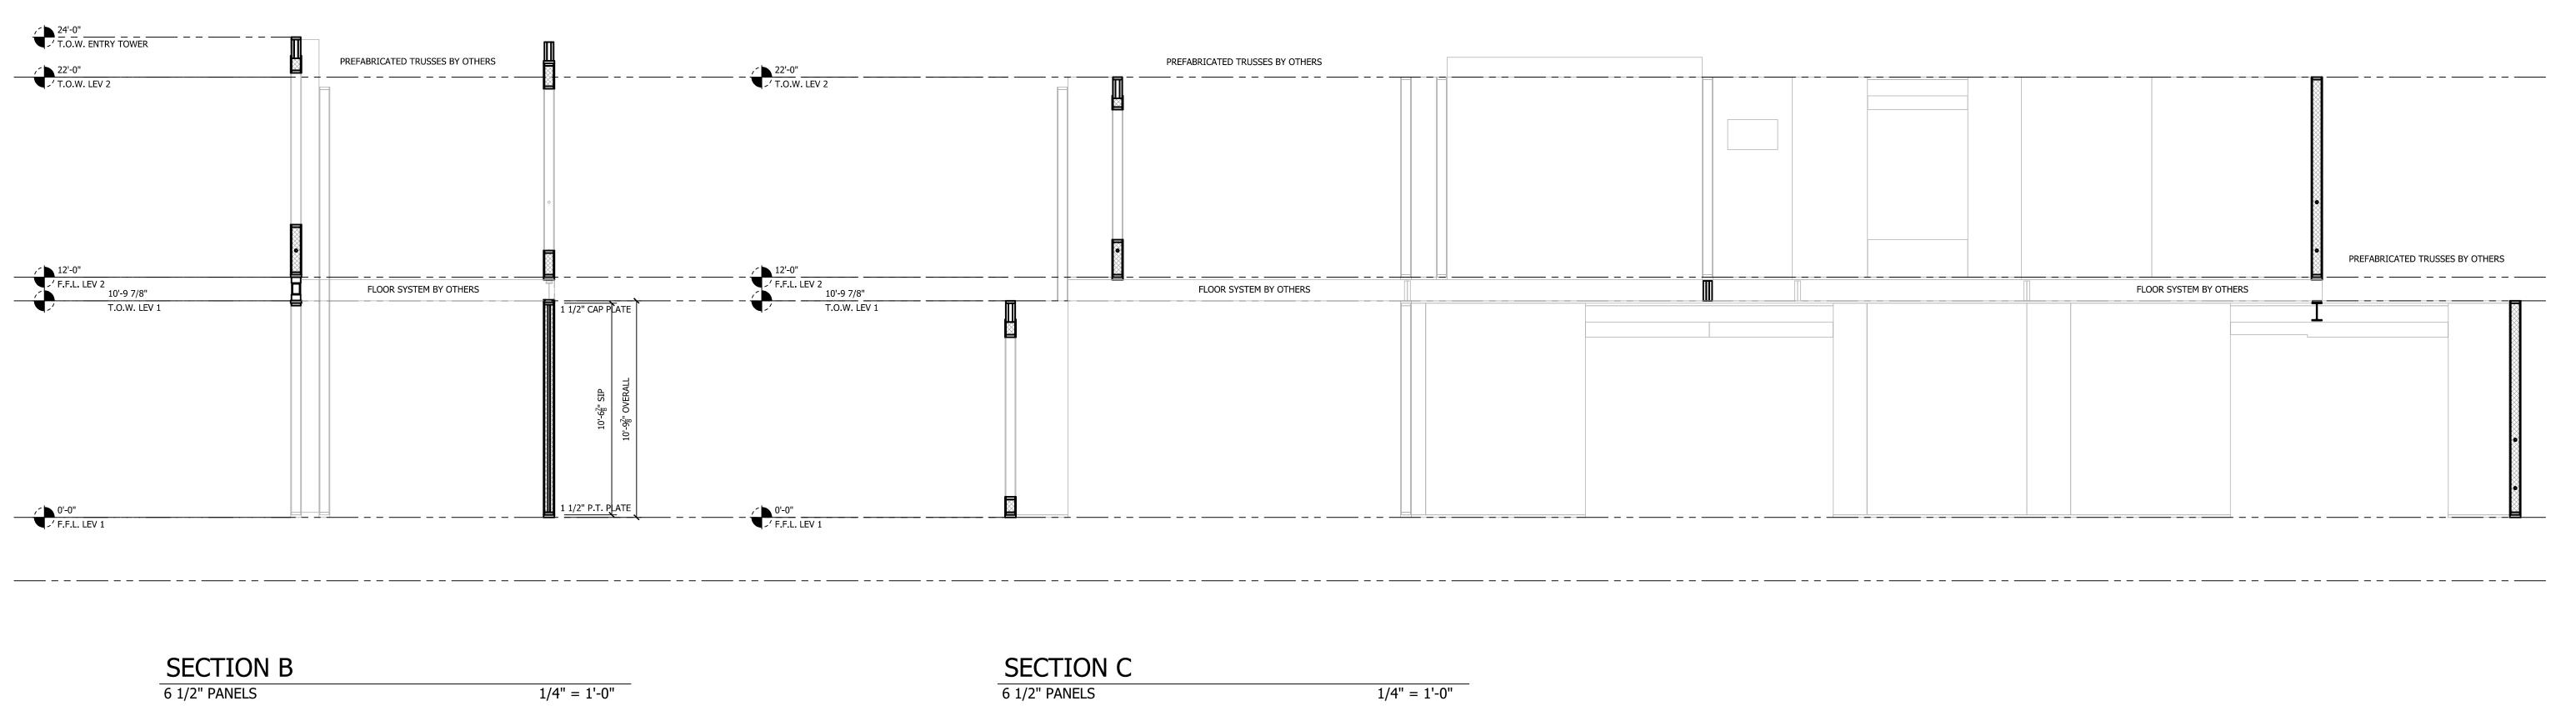

1/4" = 1'-0"


1/4" = 1'-0"




18504 Canyon Rd. E. Puyallup, Wa 98375 800-275-7086


	DATE TYPE	03/29/22 E-REV					
REVISIONS:	DRAFTER DATE	RKS 03/29,					
REVI	#	1.	2.	3.	4.	5.	

UILDING SECTIONS $\mathbf{\Omega}$

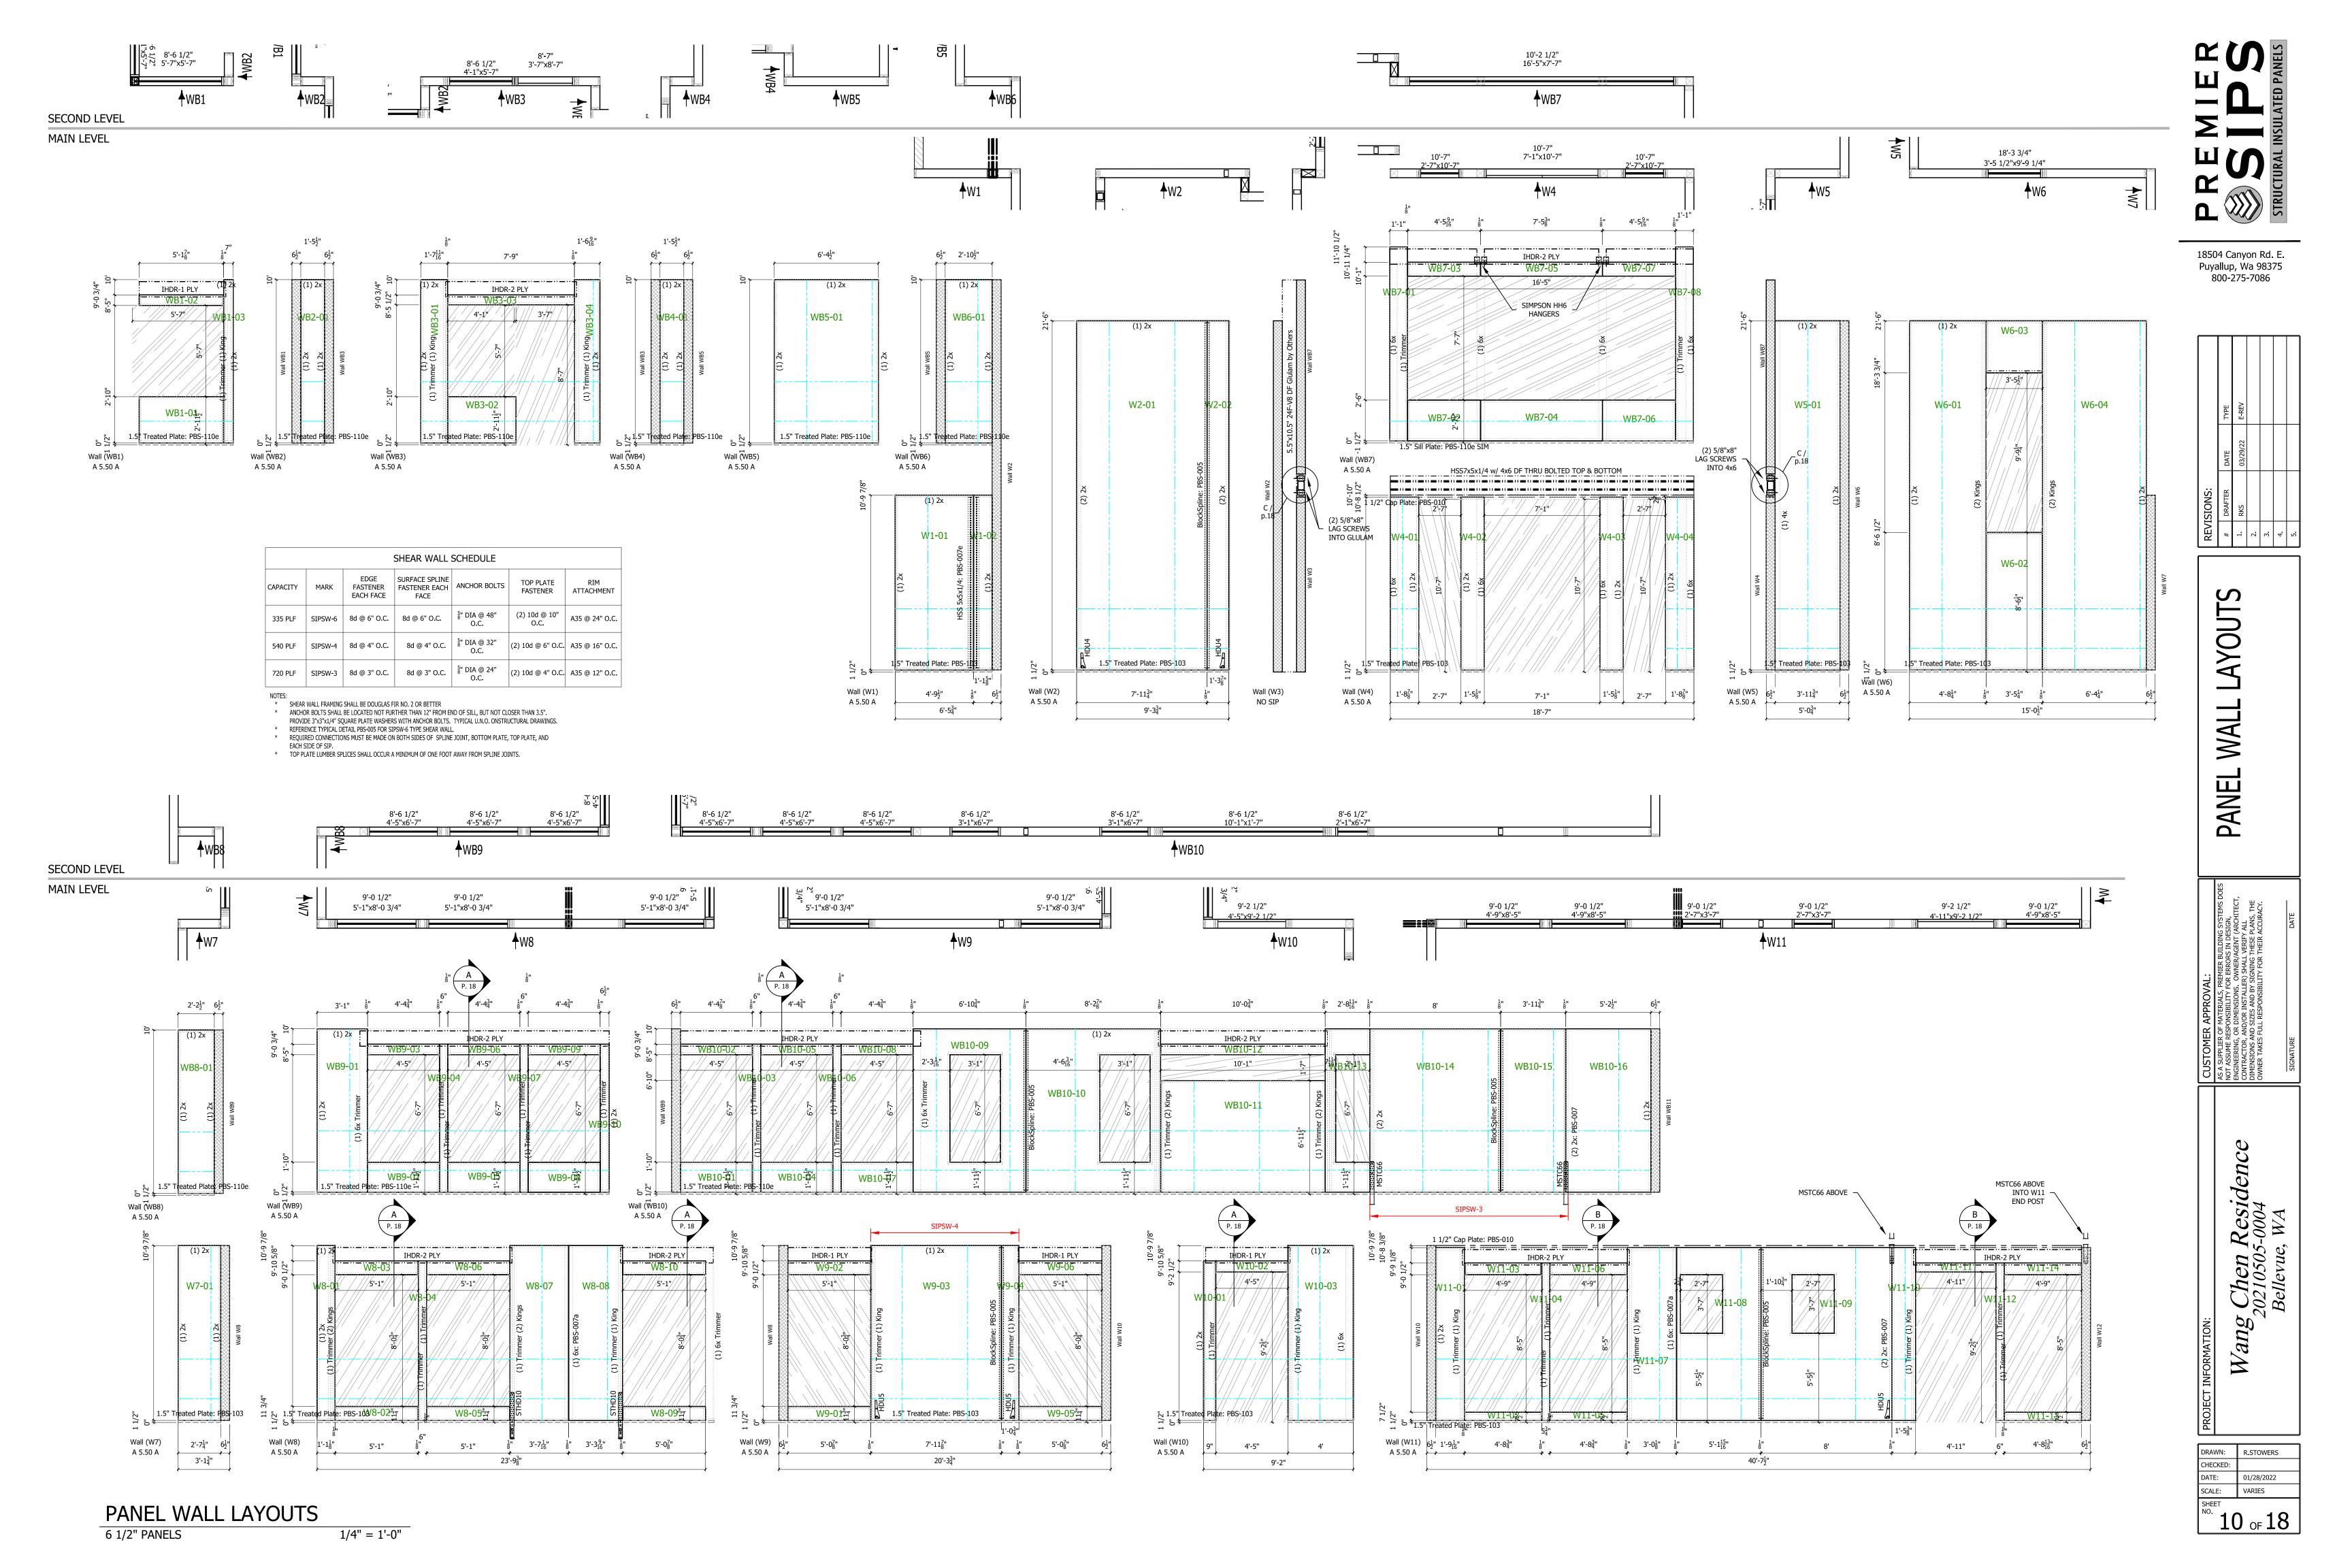



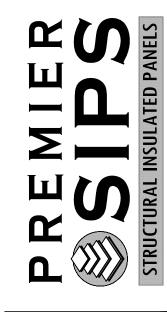

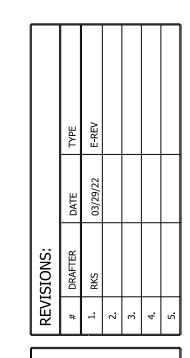

PANEL WALL LAYOUTS

	CUSTOMER APPROVAL:
ce	AS A SUPPLIER OF MATERIALS, PREMIER BUILDING SYSTEMS DOES NOT ASSUME RESPONSIBILITY FOR ERRORS IN DESIGN, ENGINEERING, OR DIMENSIONS. OWNER/AGENT (ARCHITECT, CONTRACTOR, AND/OR INSTALLER) SHALL VERIFY ALL DIMENSIONS AND SIZES AND BY SIGNING THESE PLANS, THE OWNER TAKES FULL RESPONSIBILITY FOR THEIR ACCURACY.

Wang Chen Residence 20210505-0004 Bellevue, WA

DRAWN: R.STOWERS

CHECKED:


DATE: 01/28/2022

SCALE: VARIES


SHEET

SHEET NO. 11 OF 18



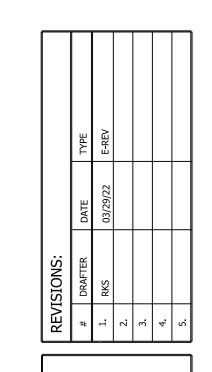


LAYOUTS WALL **PANEL**

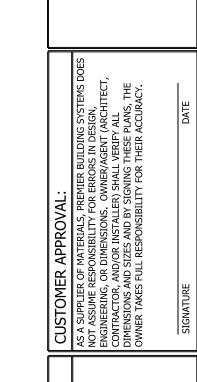


Wang Chen Residenc 20210505-0004 Bellevue, WA

DRAWN: CHECKED: R.STOWERS 01/28/2022 SCALE: VARIES

12 of 18

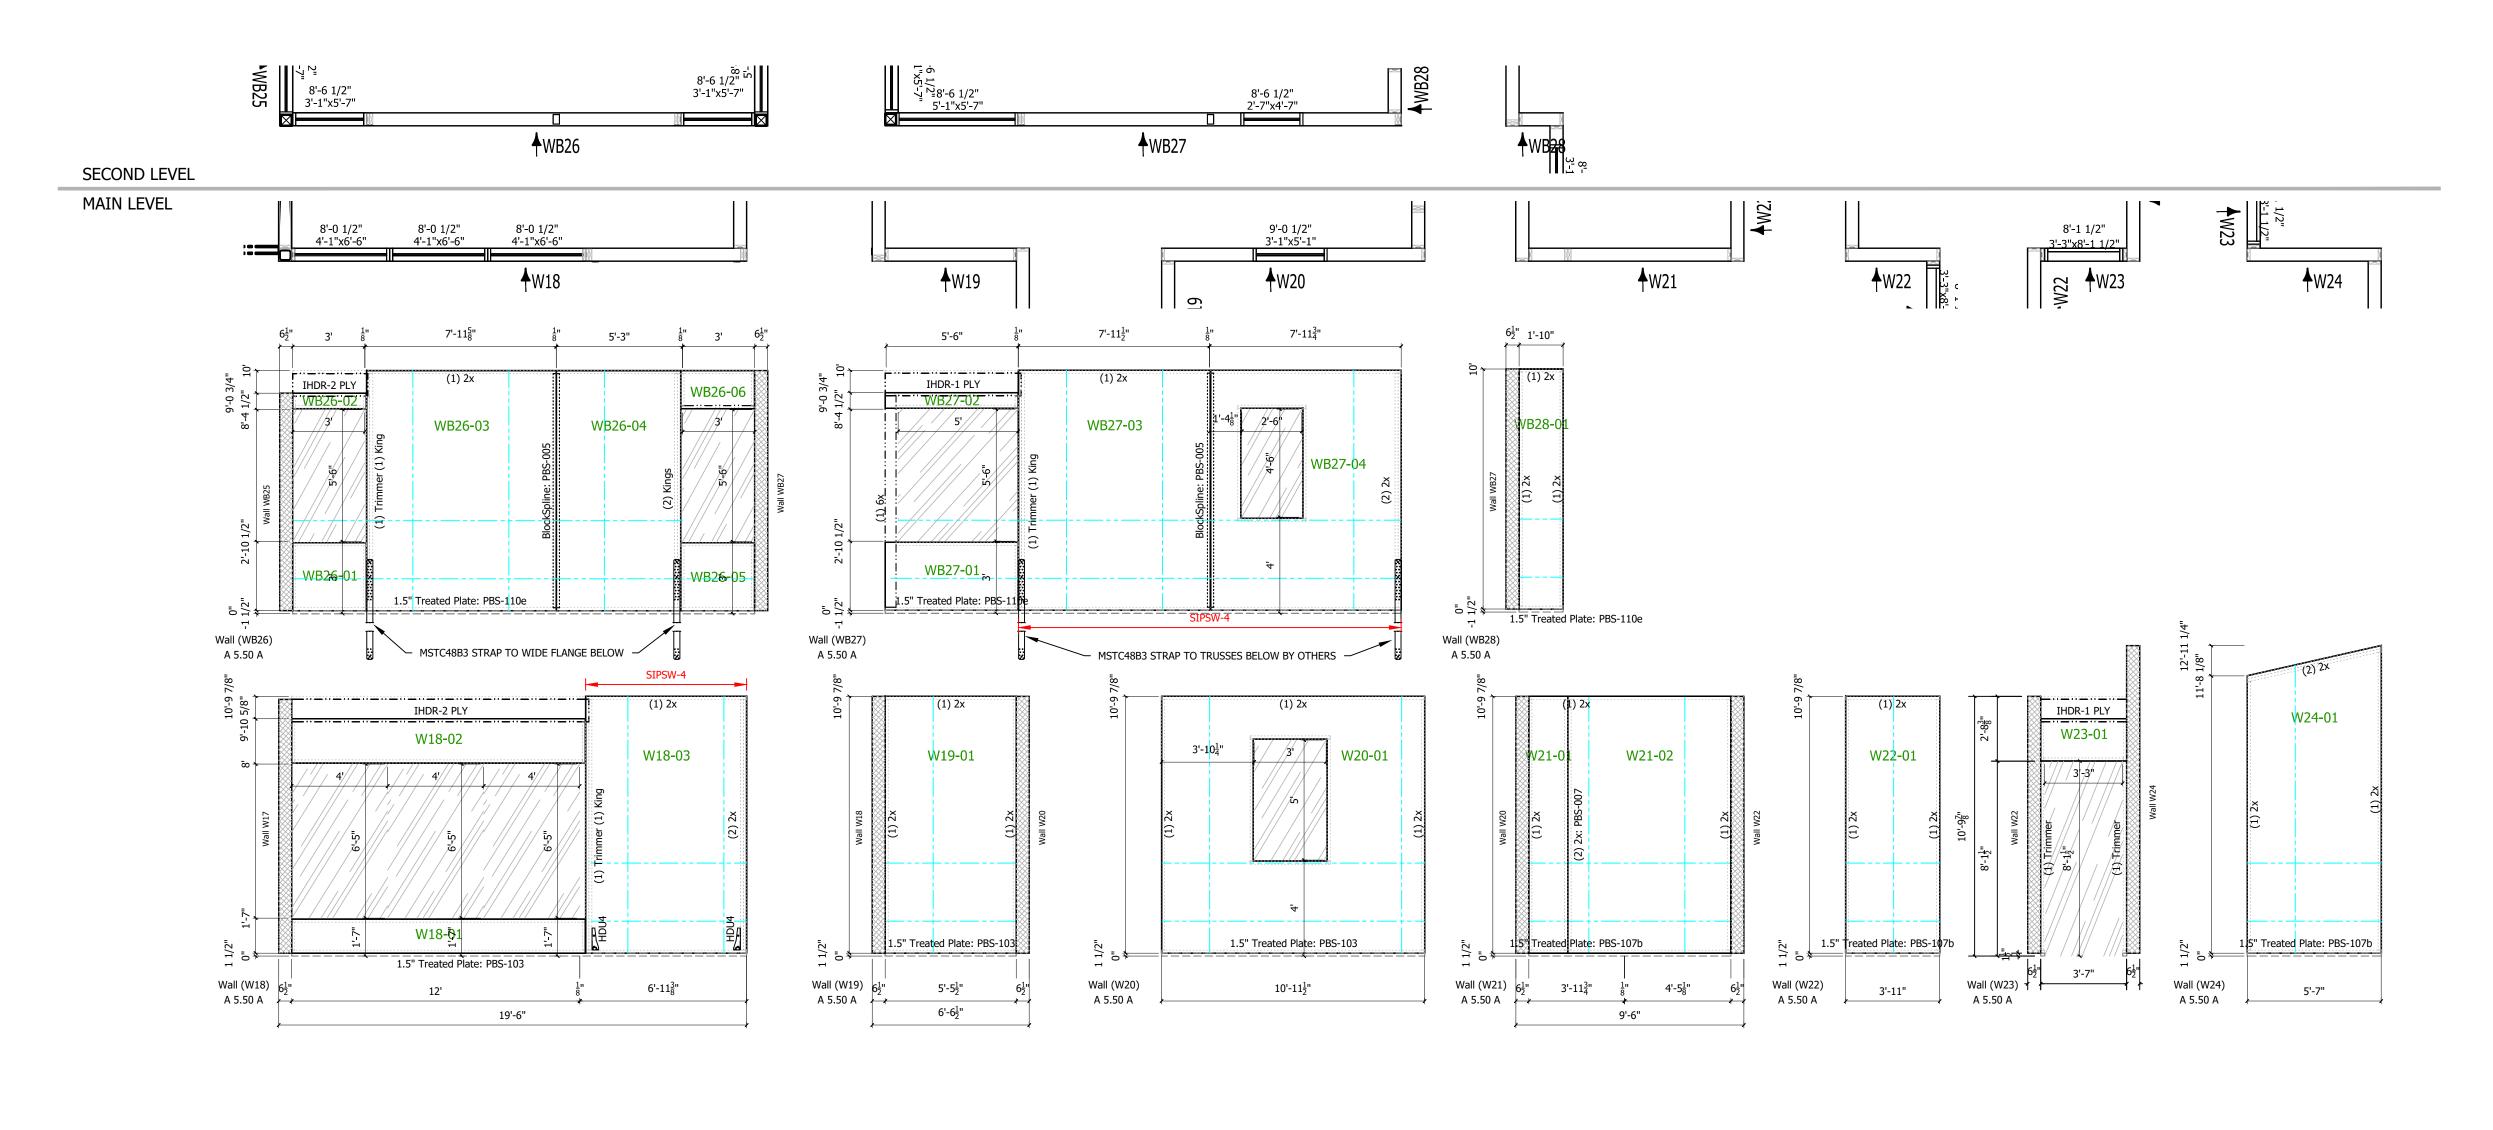

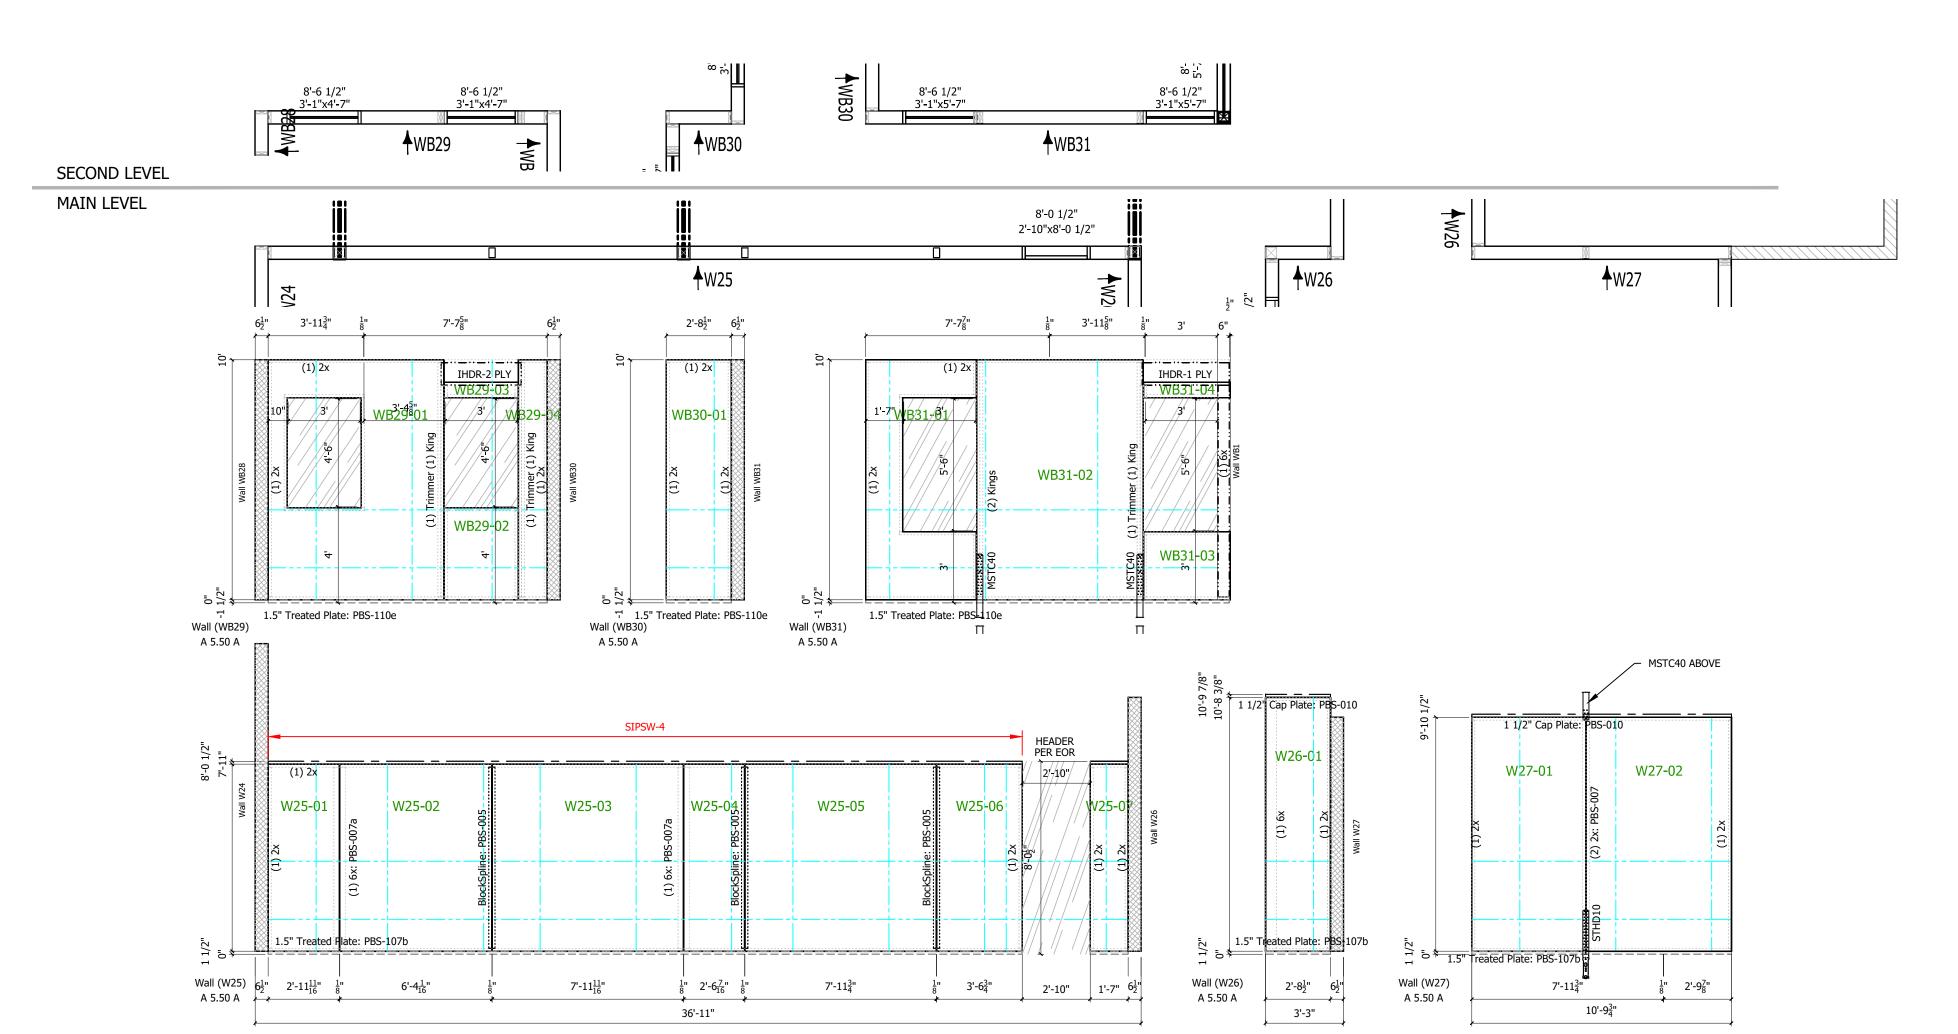

			SHEAR WALL	SCHEDULE		
CAPACITY	MARK	EDGE FASTENER EACH FACE	SURFACE SPLINE FASTENER EACH FACE	ANCHOR BOLTS	TOP PLATE FASTENER	RIM ATTACHMENT
335 PLF	SIPSW-6	8d @ 6" O.C.	8d @ 6" O.C.	§" DIA @ 48" O.C.	(2) 10d @ 10" O.C.	A35 @ 24" O.0
540 PLF	SIPSW-4	8d @ 4" O.C.	8d @ 4" O.C.	5/8" DIA @ 32" O.C.	(2) 10d @ 6" O.C.	A35 @ 16" O.0
720 PLF	SIPSW-3	8d @ 3" O.C.	8d @ 3" O.C.	5/8" DIA @ 24" O.C.	(2) 10d @ 4" O.C.	A35 @ 12" O.0

- NOTES:

 * SHEAR WALL FRAMING SHALL BE DOUGLAS FIR NO. 2 OR BETTER


 * ANCHOR BOLTS SHALL BE LOCATED NOT FURTHER THAN 12" FROM END OF SILL, BUT NOT CLOSER THAN 3.5".


 PROVIDE 3"x3"x1/4" SQUARE PLATE WASHERS WITH ANCHOR BOLTS. TYPICAL U.N.O. ONSTRUCTURAL DRAWINGS.


 * REFERENCE TYPICAL DETAIL PBS-005 FOR SIPSW-6 TYPE SHEAR WALL.

 * REQUIRED CONNECTIONS MUST BE MADE ON BOTH SIDES OF SPLINE JOINT, BOTTOM PLATE, TOP PLATE, AND EACH SIDE OF SIP.

 * TOP PLATE LUMBER SPLICES SHALL OCCUR A MINIMUM OF ONE FOOT AWAY FROM SPLINE JOINTS.

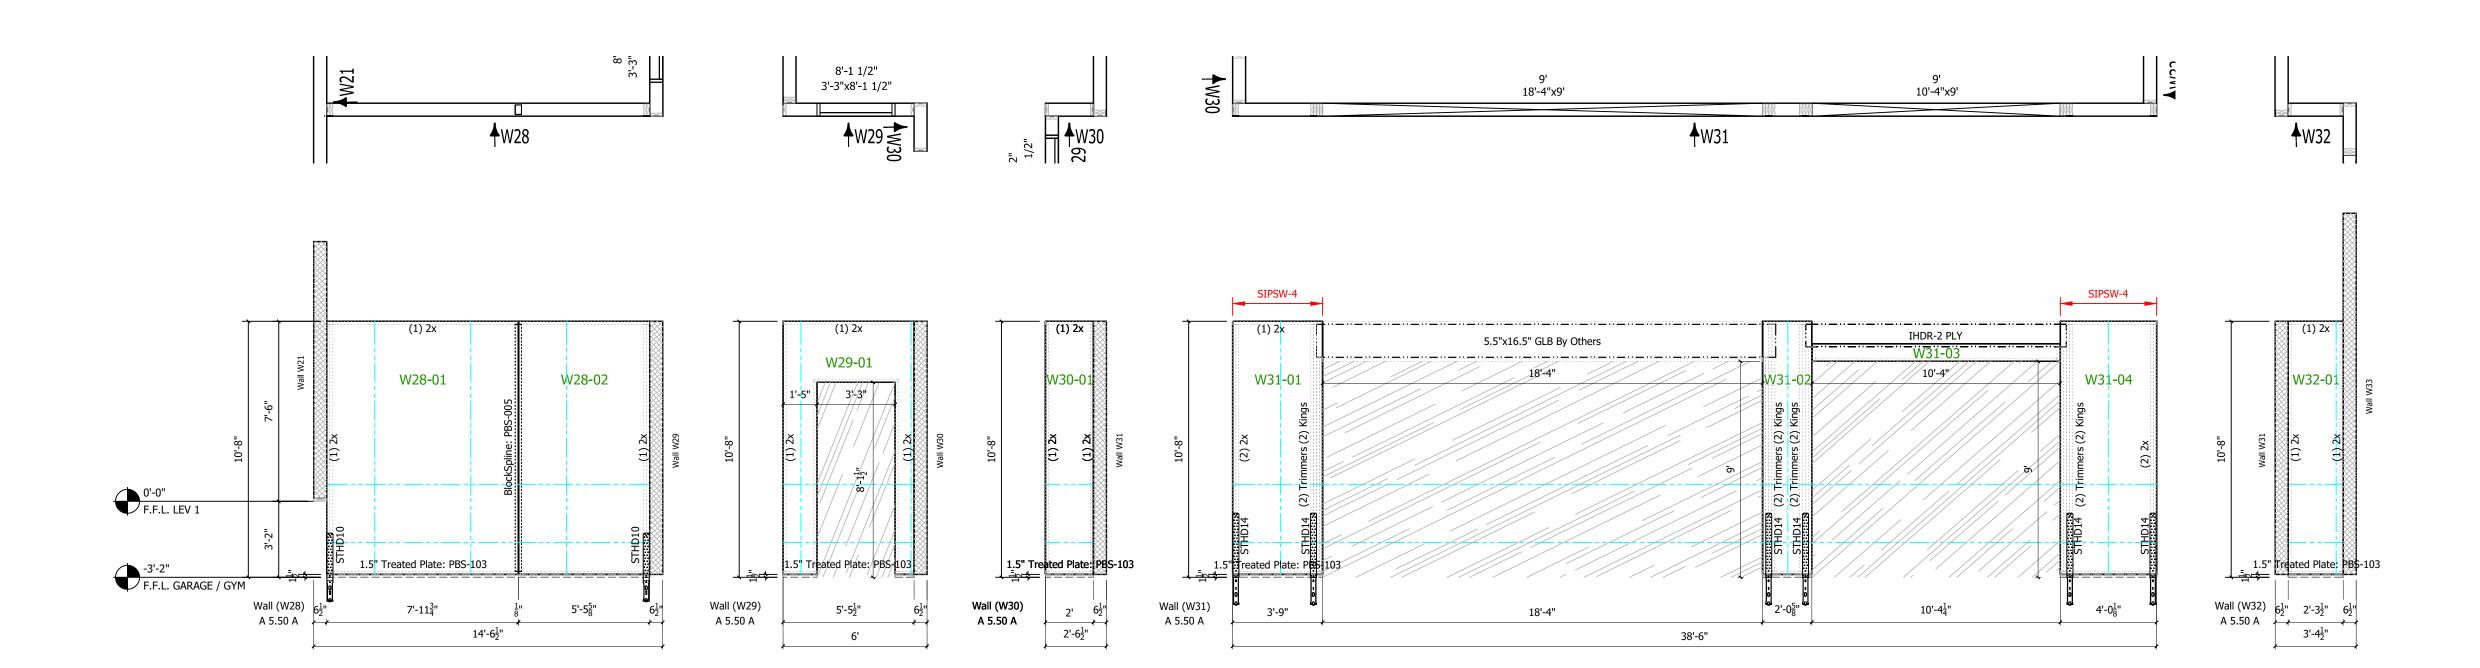

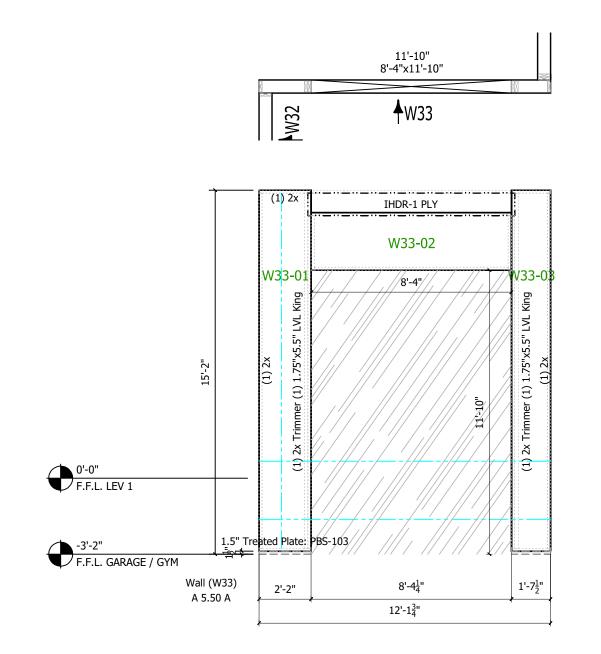

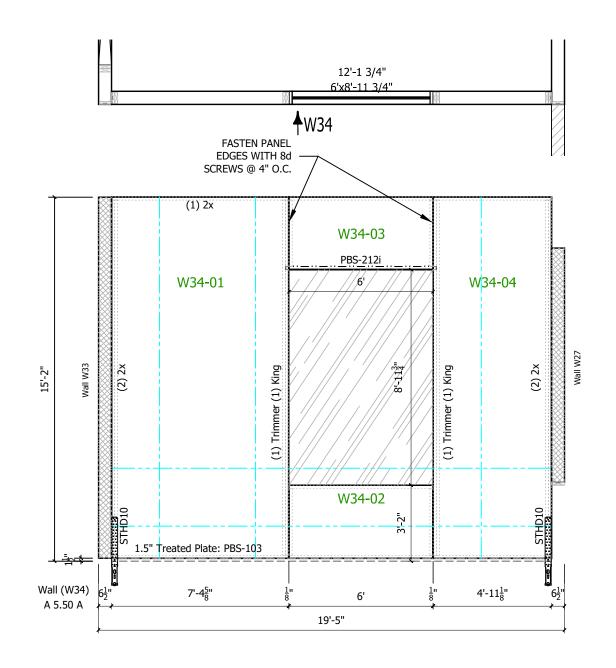

			SHEAR WALL	SCHEDULE		
CAPACITY	MARK	EDGE FASTENER EACH FACE	SURFACE SPLINE FASTENER EACH FACE	ANCHOR BOLTS	TOP PLATE FASTENER	RIM ATTACHMENT
335 PLF	SIPSW-6	8d @ 6" O.C.	8d @ 6" O.C.	§" DIA @ 48" O.C.	(2) 10d @ 10" O.C.	A35 @ 24" O.C.
540 PLF	SIPSW-4	8d @ 4" O.C.	8d @ 4" O.C.	§" DIA @ 32" O.C.	(2) 10d @ 6" O.C.	A35 @ 16" O.C.
720 PLF	SIPSW-3	8d @ 3" O.C.	8d @ 3" O.C.	§" DIA @ 24" O.C.	(2) 10d @ 4" O.C.	A35 @ 12" O.C.

- NOTES:

 * SHEAR WALL FRAMING SHALL BE DOUGLAS FIR NO. 2 OR BETTER

 * ANCHOR BOLTS SHALL BE LOCATED NOT FURTHER THAN 12" FROM END OF SILL, BUT NOT CLOSER THAN 3.5".


 PROVIDE 3"x3"x1/4" SQUARE PLATE WASHERS WITH ANCHOR BOLTS. TYPICAL U.N.O. ONSTRUCTURAL DRAWINGS.

 * REFERENCE TYPICAL DETAIL PBS-005 FOR SIPSW-6 TYPE SHEAR WALL.

 * REQUIRED CONNECTIONS MUST BE MADE ON BOTH SIDES OF SPLINE JOINT, BOTTOM PLATE, TOP PLATE, AND EACH SIDE OF SIP.

 * TOP PLATE LUMBER SPLICES SHALL OCCUR A MINIMUM OF ONE FOOT AWAY FROM SPLINE JOINTS.


M M	ANELS
HO.	TED PA
Σ	INSULAT
山 ()	
	STRUCTURAL
	ST

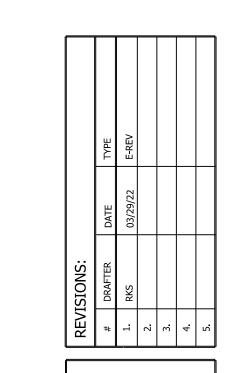


LAYOUTS PANEL WALL

CUSTOMER APPROVAL:	AS A SUPPLIER OF MATERIALS, PREMIER BUILDING SYSTEMS DOES NOT ASSUME RESPONSIBILITY FOR ERRORS IN DESIGN, ENGINERING, OR DIMENSIONS. OWNER/AGENT (ARCHITECT, CONTRACTOR, AND/OR INSTALLER) SHALL VERIFY ALL DIMENSIONS AND SIZES AND BY SIGNING THESE PLANS, THE OWNER TAKES FULL RESPONSIBILITY FOR THEIR ACCURACY.	SIGNATURE
	AS ON	

RAWN:	R.STOWERS	
IECKED:		
ATE:	01/28/2022	
CALE:	VARIES	
D. 13	3 of 18	

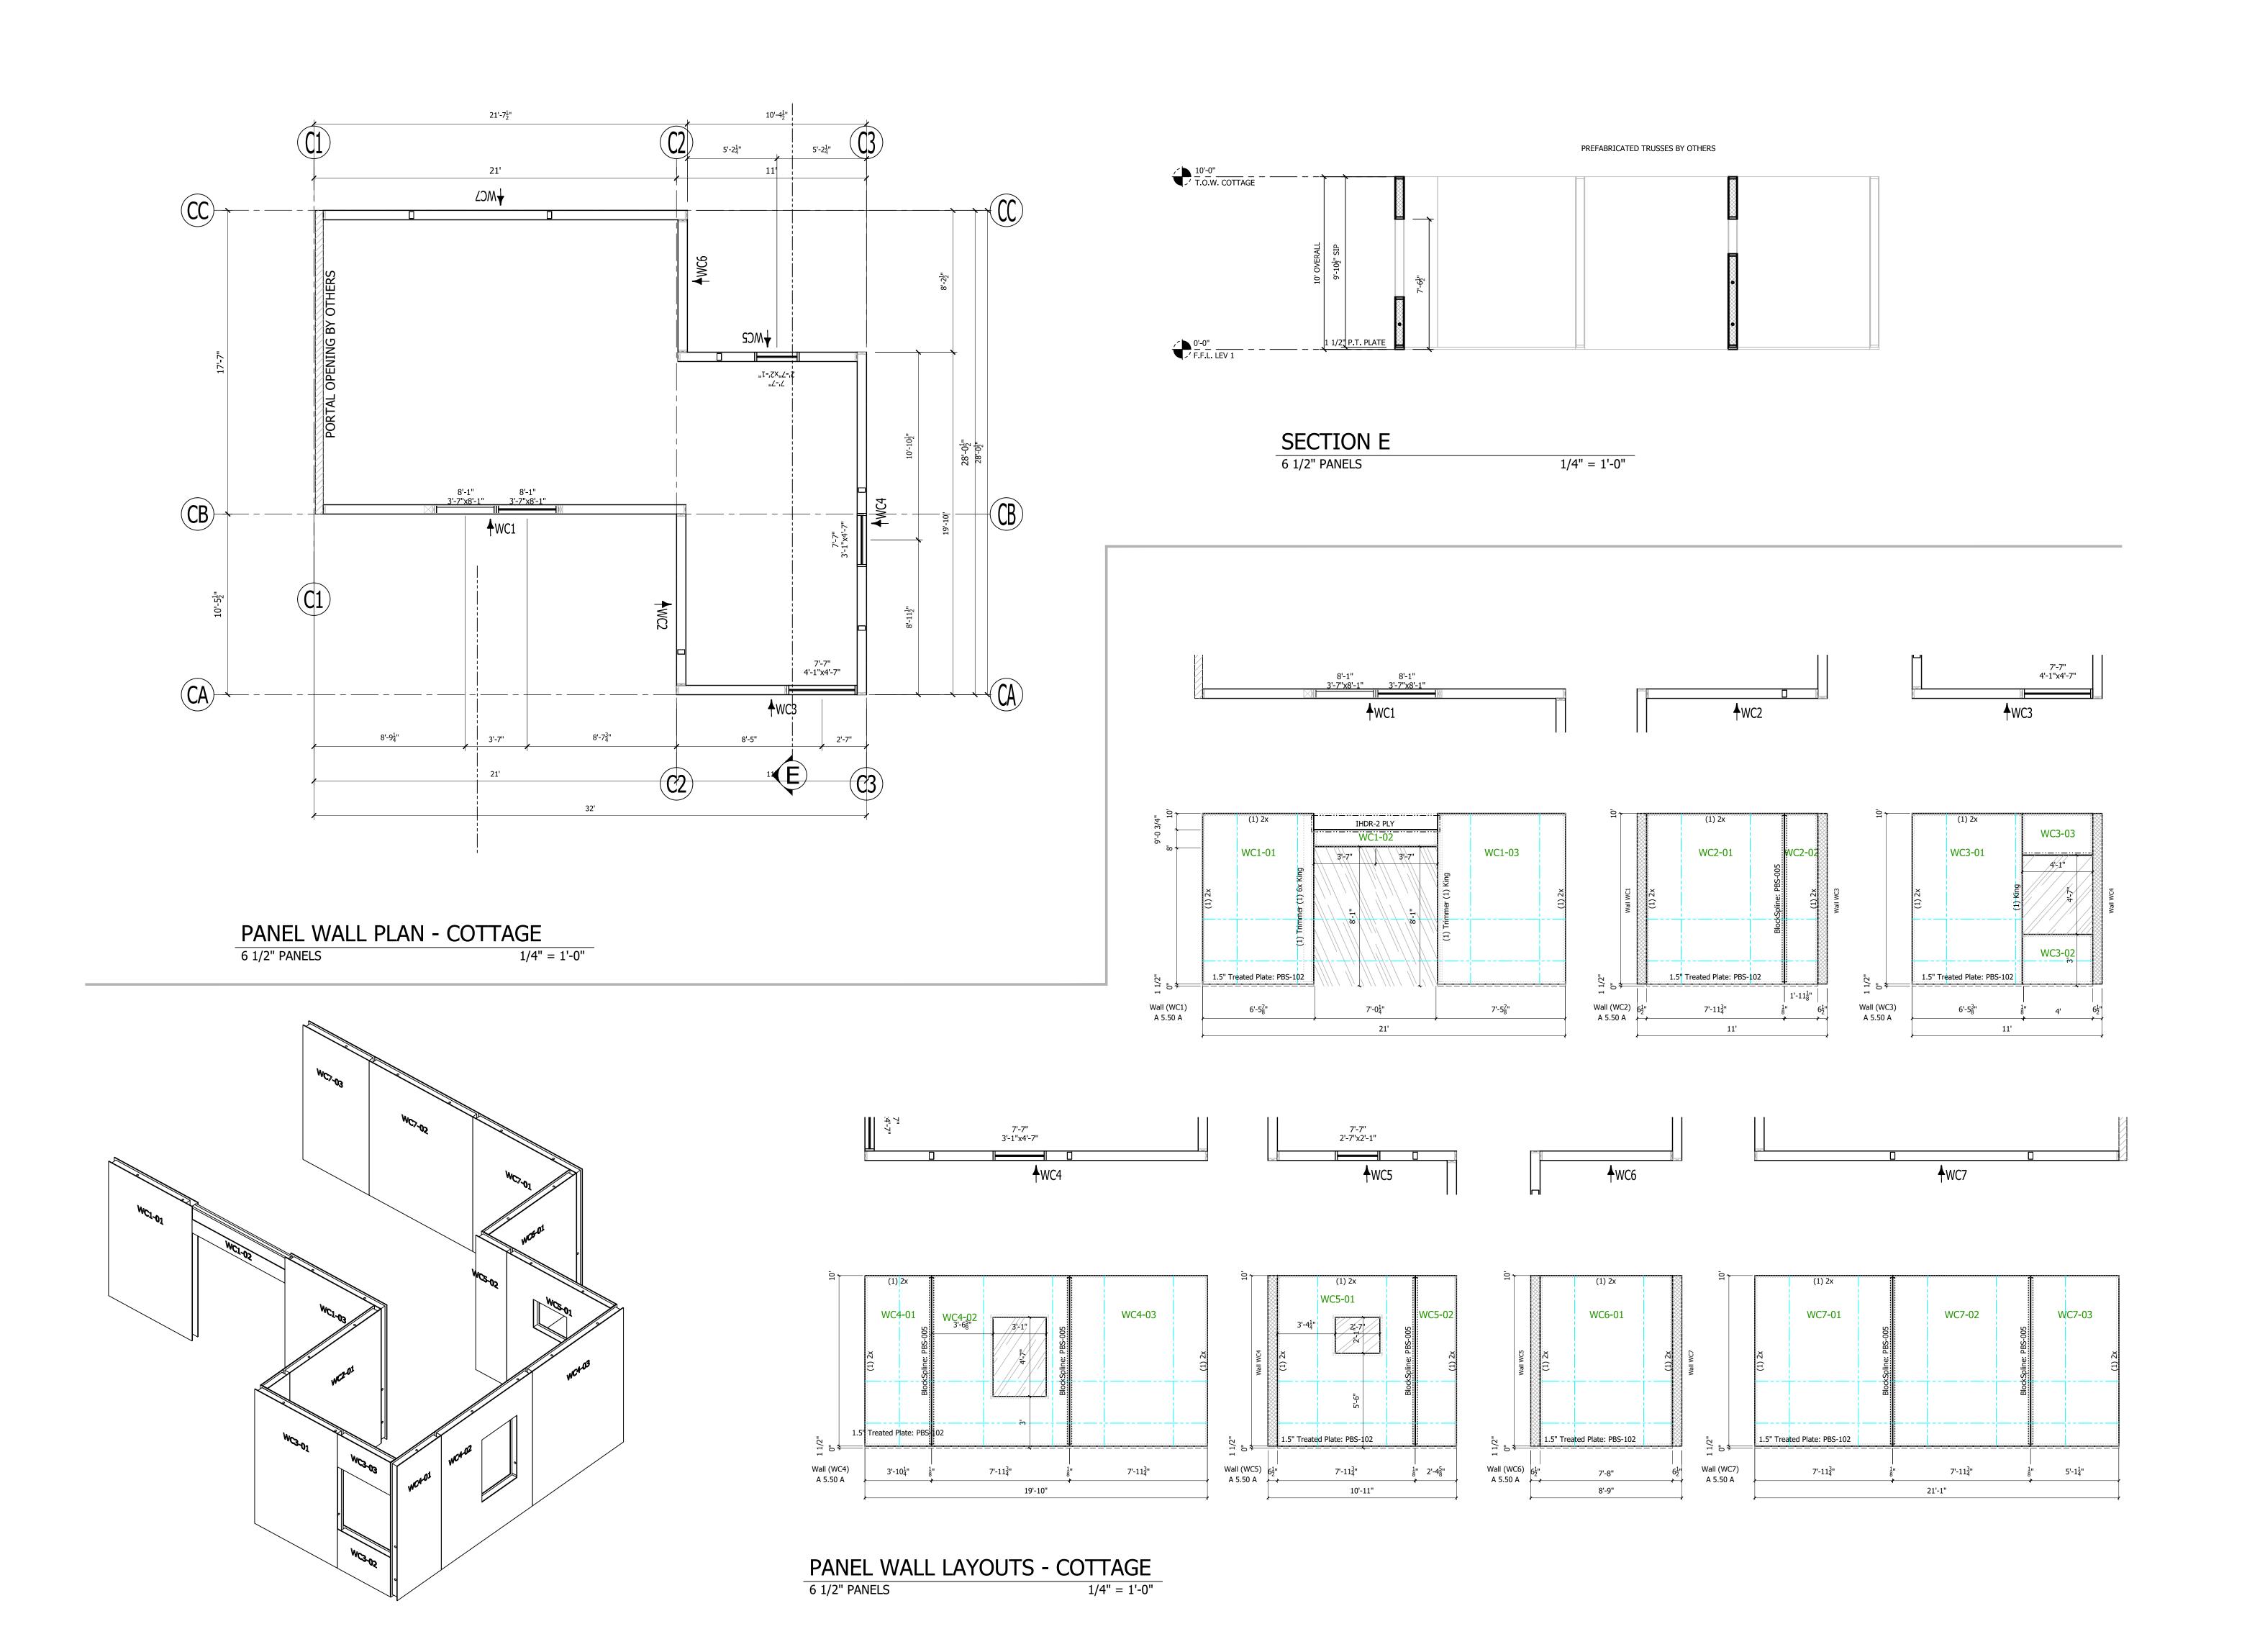

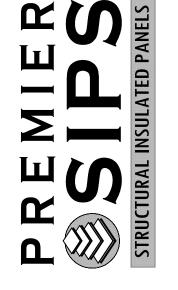

RE	REVISIONS:		
#	DRAFTER	DATE	TYPE
1.	RKS	03/29/22	E-REV
2.			
3.			
4			
5			

	REV	REVISIONS:		
UUV LUU	#	DRAFTER	DATE	TYPE
104 100	1.	RKS	03/29/22	E-REV
	2.			
_ z	3.			
	4			
	5.			

	PANEL
CUSTOMER APPROVAL:	AS A SUPPLIER OF MATERIALS, PREMIER BUILDING SYSTEMS DOES NOT ASSUME RESPONSIBILITY FOR ERRORS IN DESIGN, ENGINEERING, OR DIMENSIONS. OWNER/AGENT (ARCHITECT, CONTRACTOR, AND/OR INSTALLER) SHALL VERIFY ALL DIMENSIONS AND SIZES AND BY SIGNING THESE PLANS, THE OWNER TAKES FULL RESPONSIBILITY FOR THEIR ACCURACY.

Wang Chen Residence 20210505-0004 Bellevue, WA

14 of 18

ROJECT INFORMATION:

Wang Cher


DRAWN: R.STOWERS

CHECKED: DATE: 01/28/2022


SCALE: VARIES

SHEET NO. 15 OF 18



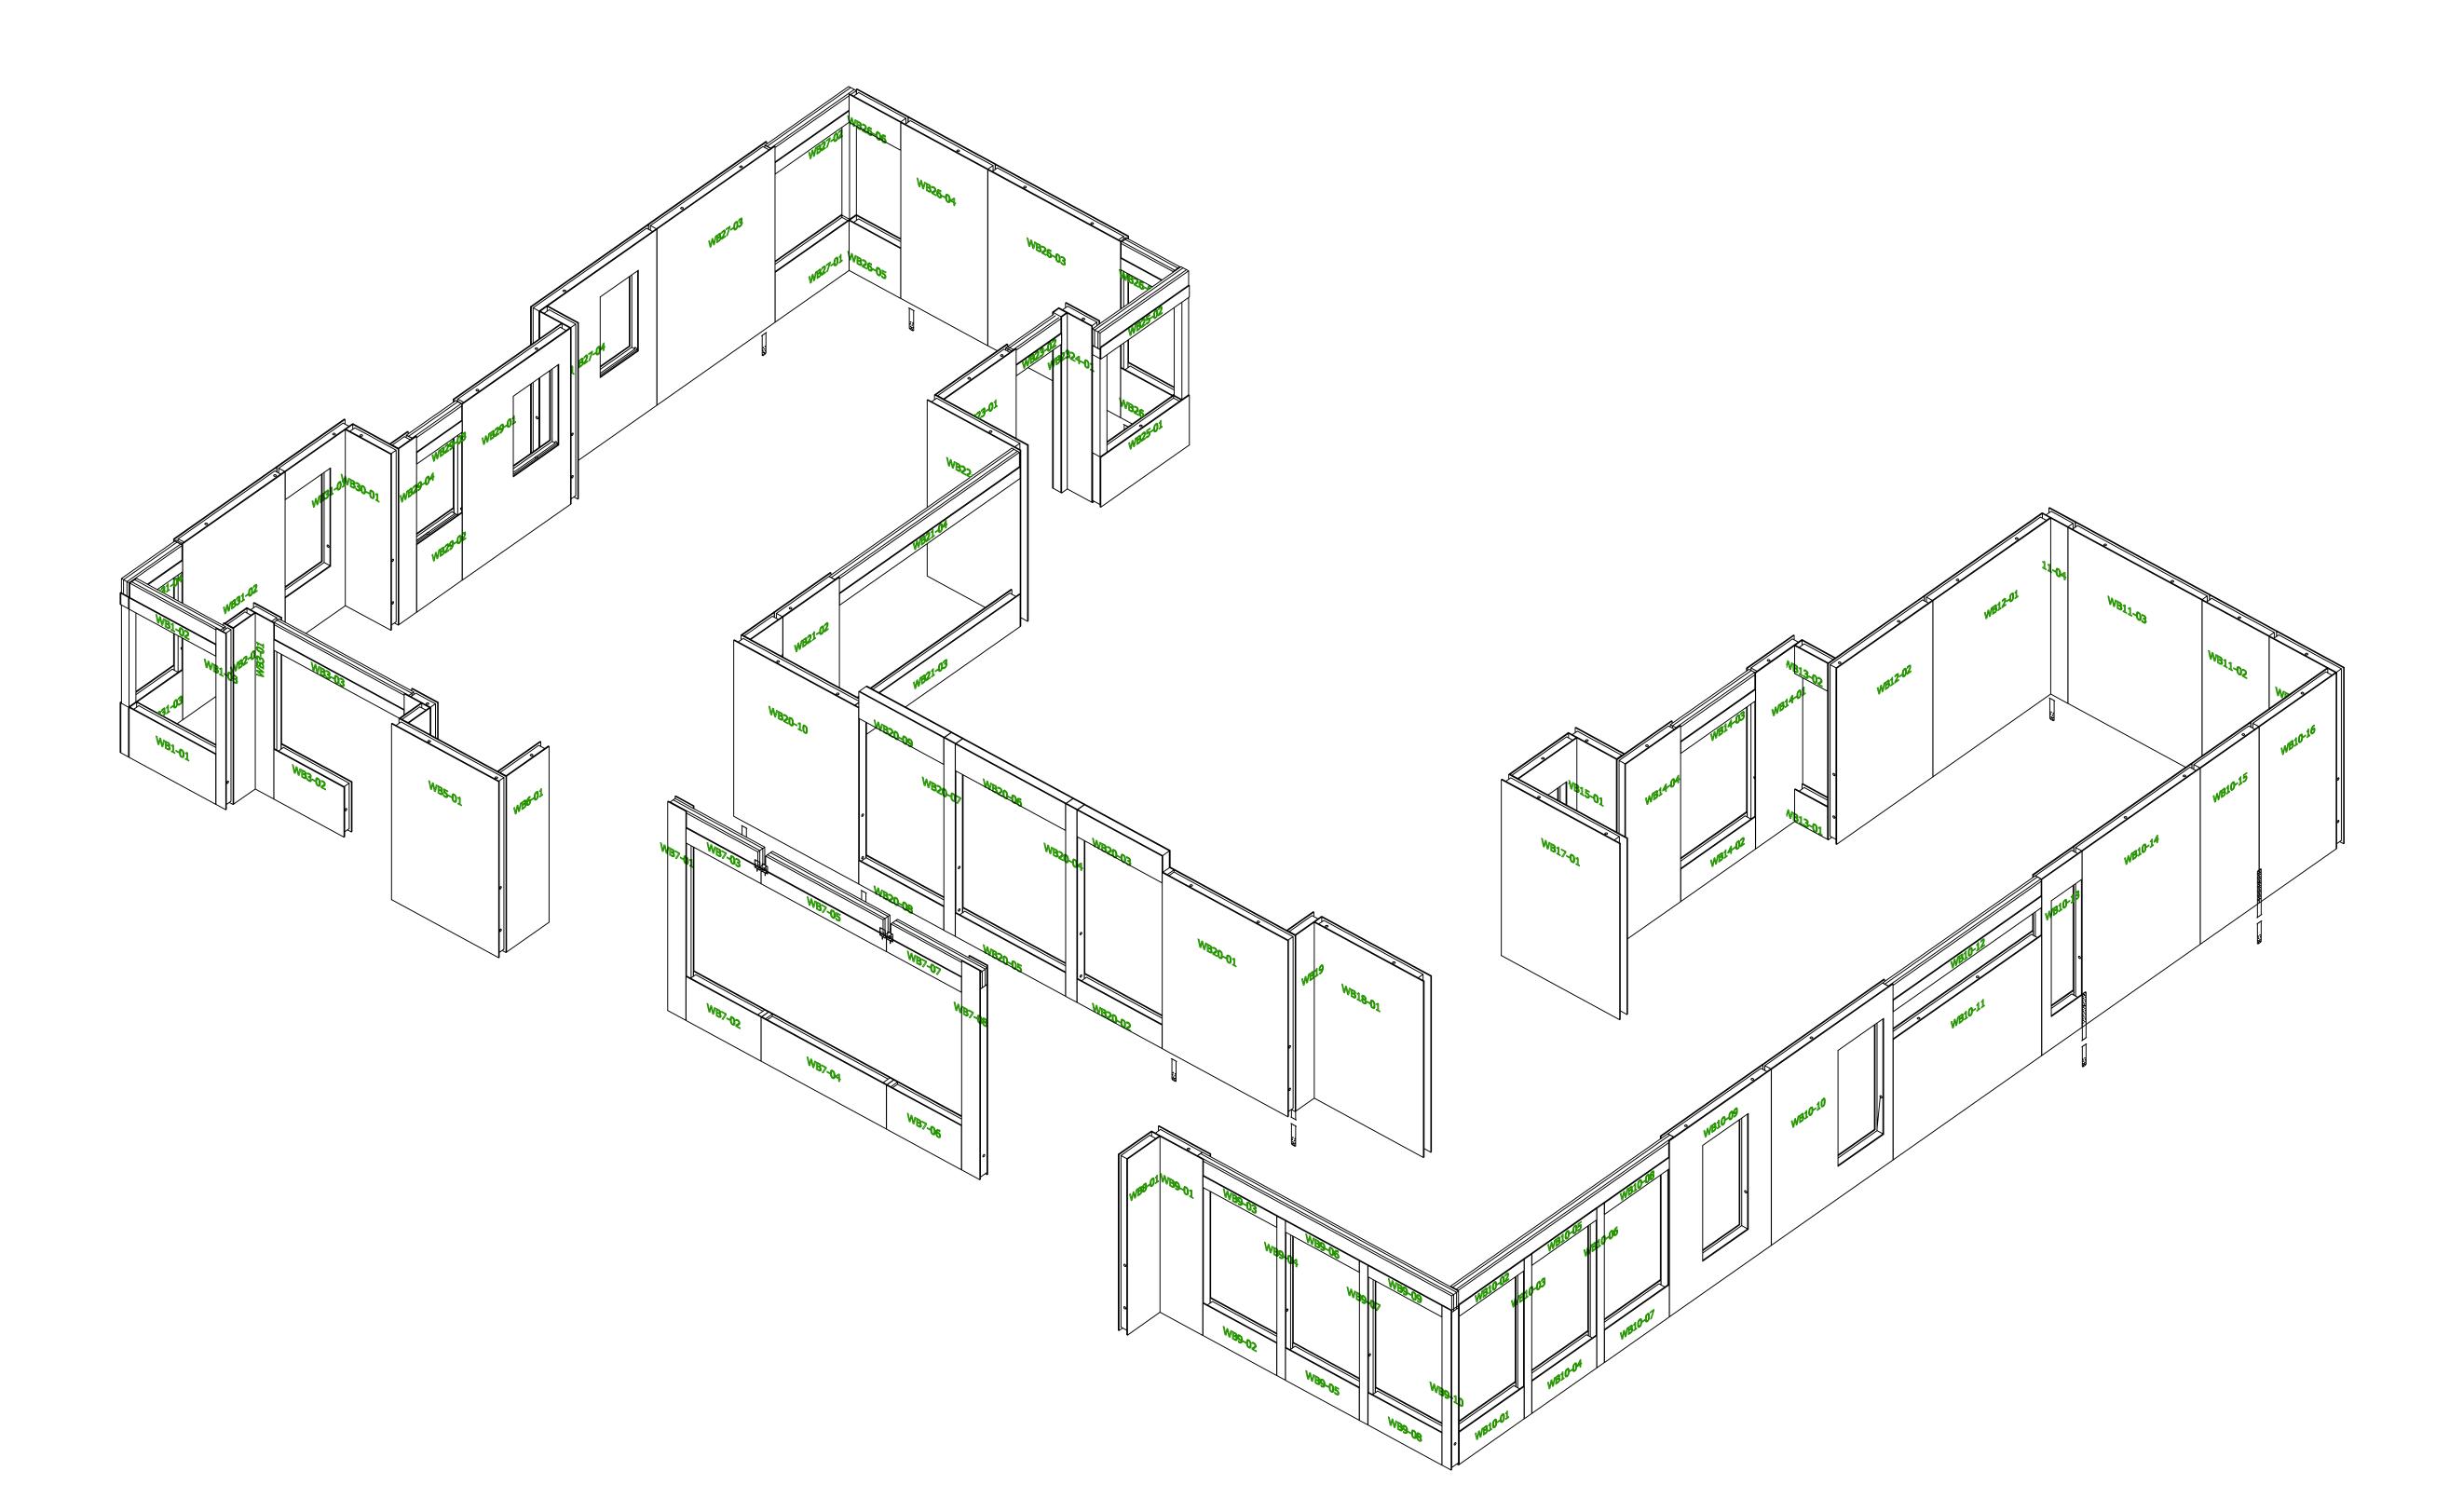


UPPER WALL PANEL PERSPECTIVE
6 1/2" PANELS

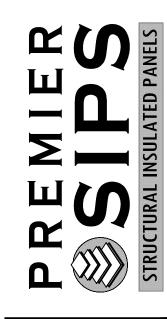

18504 Canyon Rd. E. Puyallup, Wa 98375 800-275-7086


REVISIONS: # DRAFTER DATE TYPE 1. RKS 03/29/22 E-REV 2. 3. 4.

CHECKED:	01/28/2022
SCALE:	VARIES
SHEET NO.	5 OF 18

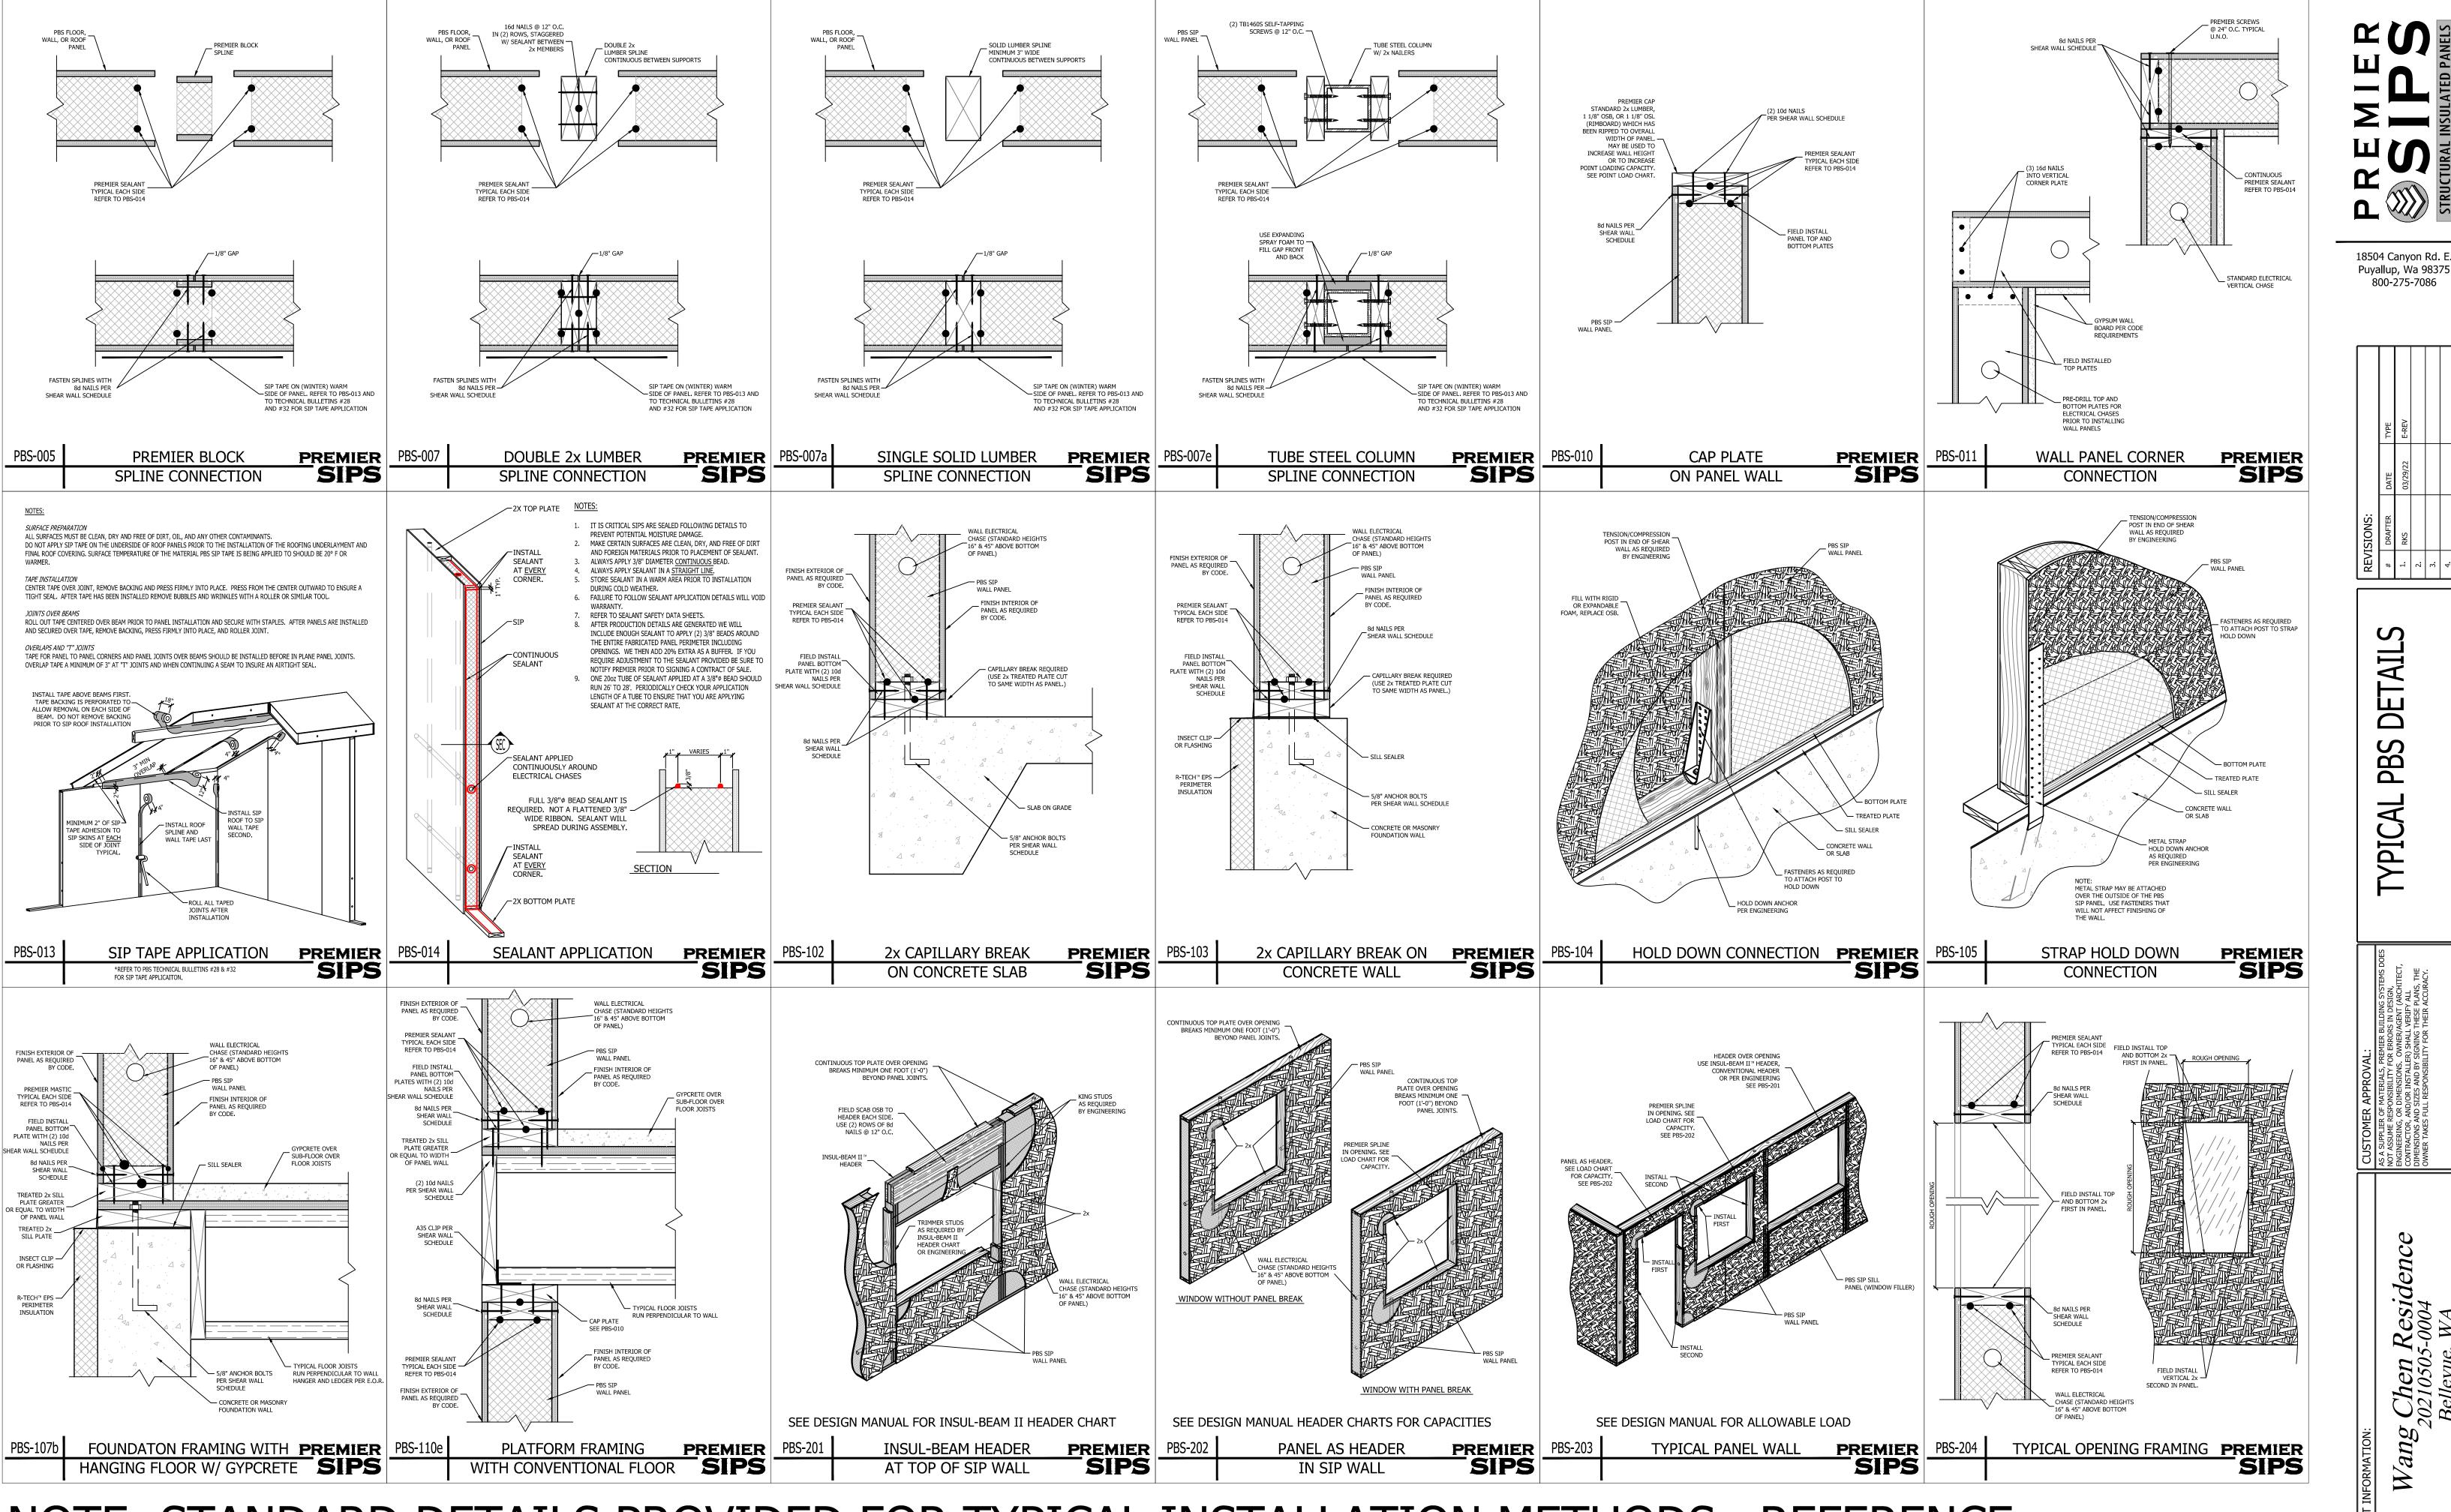


NOTE: STANDARD DETAILS PROVIDED FOR TYPICAL INSTALLATION METHODS. REFERENCE ARCHITECTURAL AND STRUCTURAL DRAWINGS FOR JOB SPECIFIC CONNECTION DETAILS, WHICH TAKE PRECEDENT OVER THESE DETAILS. FOLLOW PBS-014 FOR PROPERLY SEALING ALL SIPS.


18504 Canyon Rd. E.

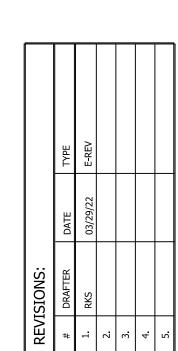

800-275-7086

 $\mathbf{\Omega}$ **Q** PI

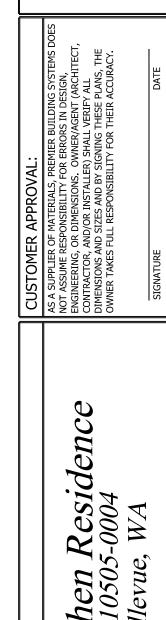


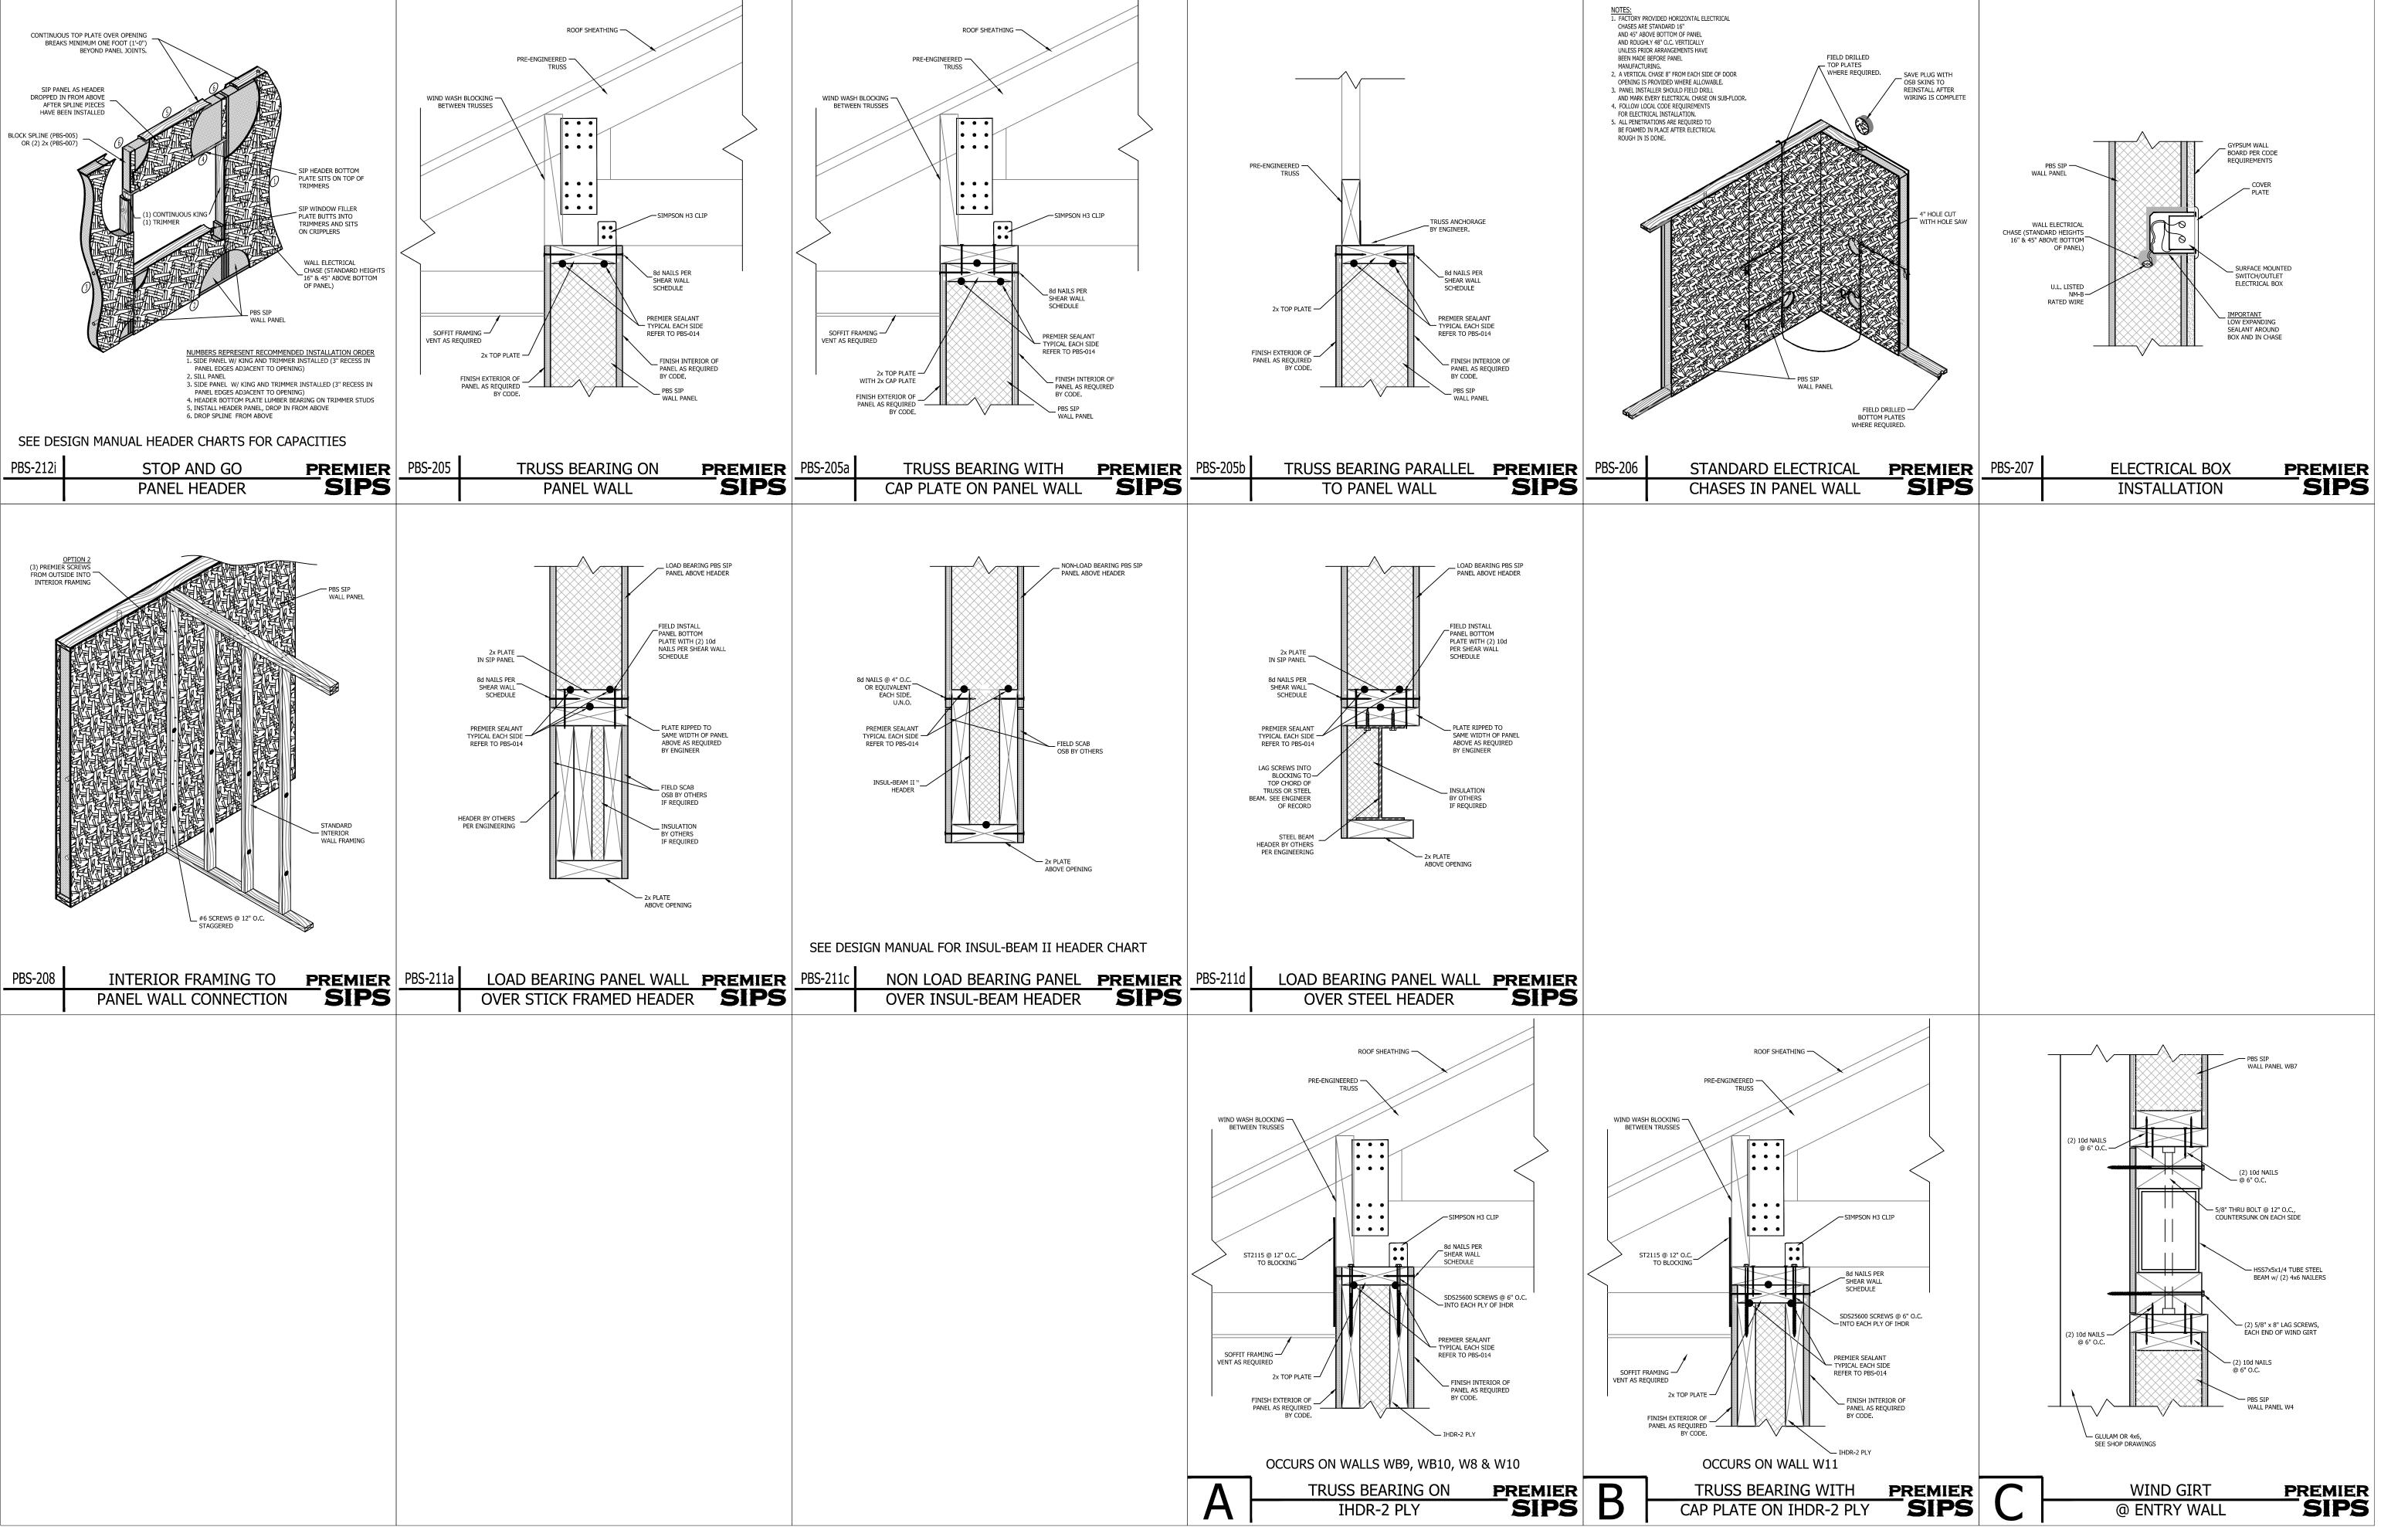


NOTE: STANDARD DETAILS PROVIDED FOR TYPICAL INSTALLATION METHODS. REFERENCE ARCHITECTURAL AND STRUCTURAL DRAWINGS FOR JOB SPECIFIC CONNECTION DETAILS, WHICH TAKE PRECEDENT OVER THESE DETAILS. FOLLOW PBS-014 FOR PROPERLY SEALING ALL SIPS.



800-275-7086

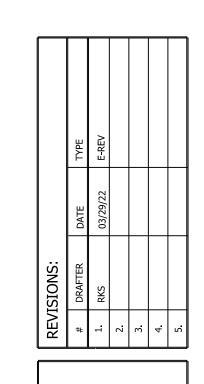

TYPICAL PBS DETAIL

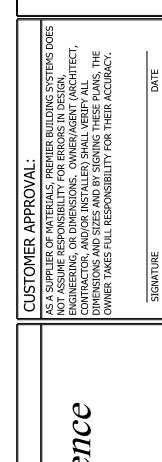

Wang Chen Residence
20210505-0004
Bellevue, WA

DRAWN: R.STOWERS

CHECKED:

DATE: 01/28/2022

SCALE: VARIES

SHEET NO. 18 OF 18